### AGENDA City of Hobbs Planning Board – Regular Meeting October 15, 2019 at 10:00 AM

W. M. "Tres" Hicks, Chairman Bill Ramirez Brett Drennan Larry Sanderson Guy Kesner, Vice Chairman Philip Ingram Ben Donahue

Tentative Agenda for the Planning Board Regular Session Meeting to be held on Tuesday, October 15, 2019 at 10:00 AM at the City of Hobbs Annex Building, <u>First Floor Commission Chambers</u> located at 200 E. Broadway, Hobbs, NM 88240.

#### **AGENDA**

- 1) Call To Order.
- 2) Review and Consider Approval of Agenda.
- 3) Review and Consider Approval of Minutes.

September 17, 2019 – Regular Meeting

- 4) Communications from Citizens.
- 5) Review and Consider Preliminary Plan for Tanglewood, Unit 4 Subdivision, as submitted by property owner, Alberto Caballero.
- 6) Review and Consider Preliminary Plan for Zia Crossing Unit 7, as submitted by property owner, Black Gold Estates, LLC.
- 7) Review and Consider Final Plat Approval for The Meadows Subdivision Unit 2, as submitted by property owner, Lemke Development, Inc.
- 8) Review Sketch Plan for proposed Subdivision located southwest of the intersection of Texas and Hannah, as submitted by property owner, Glen Payne.
- 9) Adjournment.

The City will make every effort to provide reasonable accommodations for people with disabilities who wish to attend a public meeting. Please notify the City at least 24 hours before the meeting. Telephone 397-9351.

"Notice is hereby given that a quorum of the Hobbs City Commission may be in attendance at this meeting."

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### October 15, 2019 Planning Board Regular Meeting




## SUBDIVISION PLANS

ALJO DEVELOPMENT, LLC

# TANGLEWOOD, UNIT 4 AT RANCH VIEW ESTATES

CITY OF HOBBS
LEA COUNTY, NEW MEXICO
SECTION 23 TOWNSHIP 18 SOUTH RANGE 38 EAST

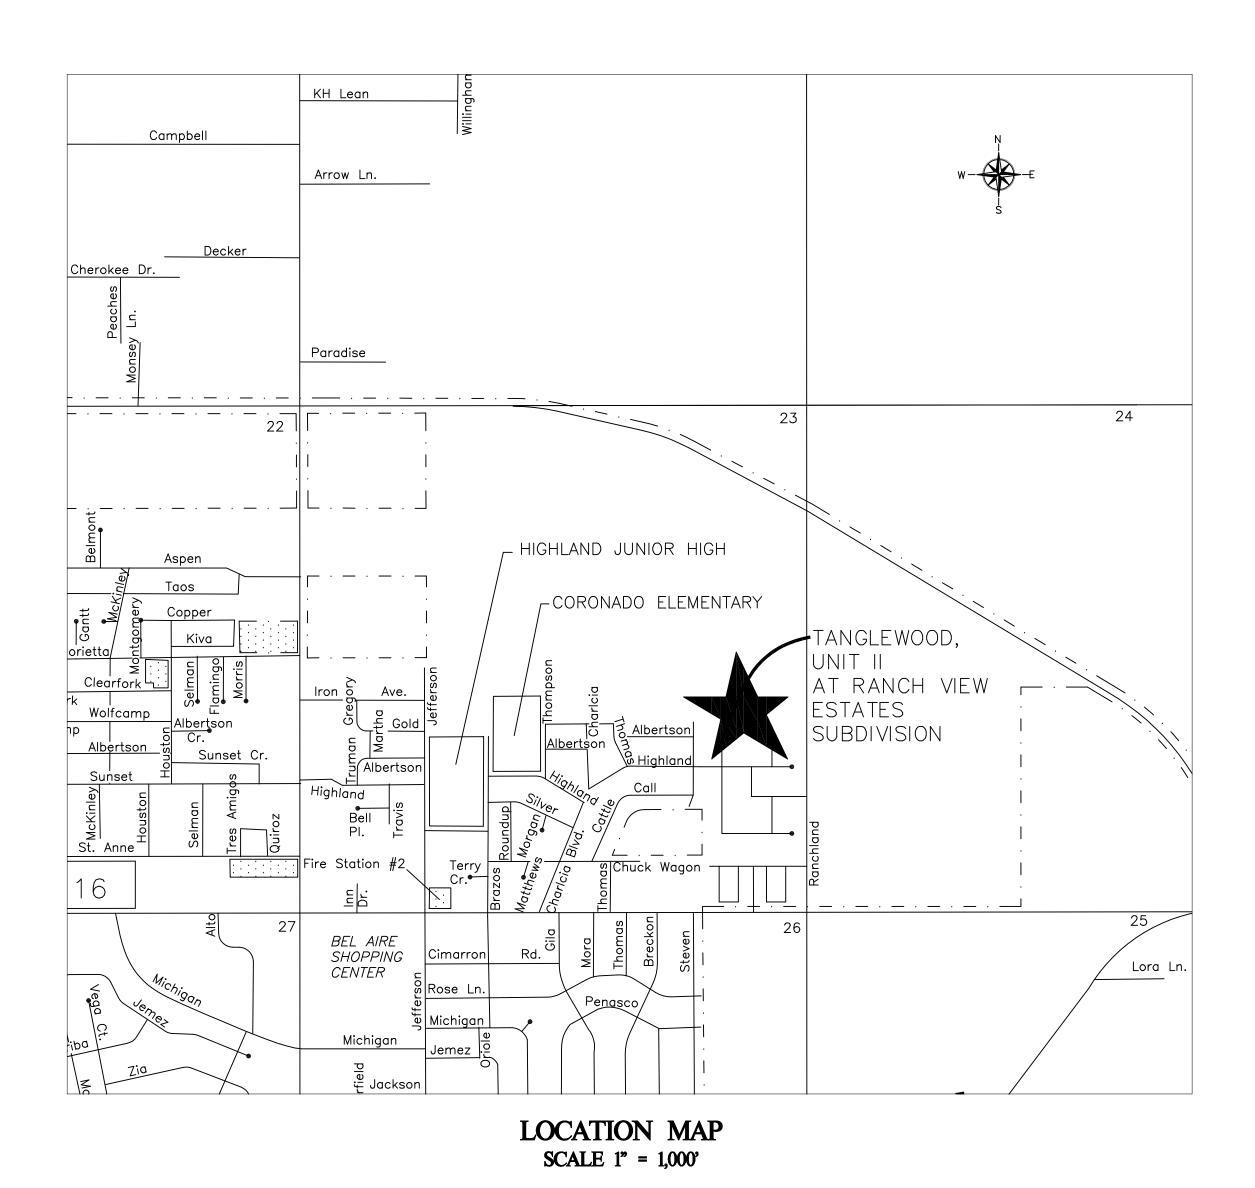

### INDEX OF SHEETS

SHEET	DESCRIPTION
1	COVER SHEET, INDEX OF DRAWINGS & LOCATION MAP
2	GENERAL NOTES
3	PRELIMINARY PLAT by John West Surveying Co.
4	MASTER LAYOUT (ROADWAYS AND UTILITIES)
5	BRECKON & ROAD "A" ROADWAY AND SEWER PLAN AND PROFILE
6	ROAD "D" ROADWAY AND SEWER PLAN AND PROFILE
7	TANGLEWOOD AVE. ROADWAY AND SEWER PLAN AND PROFILE
8	BLANK, NOT USED
9	ROAD "E" ROADWAY AND SEWER PLAN AND PROFILE
10	ROAD "A2" ROADWAY AND SEWER PLAN AND PROFILE
11	ROAD "F" ROADWAY AND SEWER PLAN AND PROFILE
12	INTERSECTION DETAILS 1
13	INTERSECTION DETAILS 2
14	ROADWAY DETAILS
15	WATER DETAILS
16	SEWER DETAILS
17	SEWER DETAILS (CONTINUED)
18	MISCELLANEOUS DETAILS
19	ELECTRICAL TRENCH LAYOUT BY XCEL ENERGY INC.

### SPECIFICATIONS: Street Construction

- 1. All work shall meet or exceed the applicable requirements of the "New Mexico Standard Specifications for Public Works Construction" 1987 Edition (herein—after abbreviated NMSS), except as otherwise specified herein.
- 2. Earthwork shall be considered incidental to the street construction unless otherwise indicated in the bid proposal. All roots and other vegetation shall be removed from areas to be covered by asphalt or concrete. The subgrade shall be accurately shaped to lines and grades as indicated on the details. Minimum compaction in areas not otherwise shown shall be 90% of the maximum density as determined by ASTM D-1557, Method A.
- 3. All Portland Cement Concrete for pavement shall conform to NMSH&TD Specification— Section 451 or Section 503, for structures. The contractor shall submit a proposed job mix for the engineer's approval in ample time before placing any concrete.
- 4. Base course materials and placement shall conform to the requirements of NMSH&TD Specification, Section 304—Base Course. The contractor shall submit an aggregate analysis for the engineer's approval in ample time before placing any base course material.
- 5. Prime coat material and placement shall conform to the requirements of NMSH&TD Specifications, Section 408—Prime Coat. The contractor shall submit certification of quality for his proposed material for the engineer's approval in ample time before placing any prime coat.
- 6. Asphaltic concrete surface course material and placement shall conform to the requirements of NMSH&TD Specification, Section 420 OR 422—Plant Mix Bituminous Pavement (Dense Graded or Super Pave). The contractor shall submit a proposed mix design for the engineer's approval in ample time before placing any surface course.
- 7. The water and sewer contractor shall complete his work, including trench compaction and clean—up, in any one street before the paving contractor starts final subgrade preparation for the street construction. Final adjustment to grade of valve boxes and manhole covers, pouring concrete collars, etc., shall be left for the paving contractor.
- 8. All construction, including compaction, shall be guaranteed for a period of 12 months after completion of construction.

### <u>SPECIFICATIONS — Water and Sewer Systems</u>

- 1. All work shall meet or exceed the applicable requirements of the "New Mexico Standard Specifications for Public Works Construction", 1987 Edition (herein—after abbreviated NMSS), except as otherwise specified herein
- 2. Manufacturer's brochure cuts, and certificates of quality where applicable, shall be submitted for the engineer's approval for all items installed on the job.
- 3. Water mains shall be PVC Water Pressure Pipe, Class 150, DR 18, C-900 water pipe as specified in NMSS Section 121, joints may be either mechanical or push—on type except where otherwise specifically indicated, or shall be Polyethylene Water Pressure Pipe, DR 17 as specified by AWWA C-906.
- 4. The use of tapping sleeves for connection to existing mains or repair sleeves will not be permitted except with the express permission of the engineer for each instance.
- 5. Water service lines shall be 1" diameter, polyethylene tubing and accessories shall conform with NMSS Section 560.2 Water Service Pipe.
- 6. All sections of new water mains shall be hydrostatically tested in accordance with AWWA C-600, Sec. 13, in the presence of the engineer and a city representative. The contractor shall furnish all equipment and labor required to make the tests. The mains shall be tested with the service connections complete in place. The leakage shall not exceed the calculated allowable leakage as specified in test sheet 801.16.2 in NMSS Section 801. The contractor shall locate and repair all leaks until there are no visible leaks and the overall leakage is within the specified maximum.
- 7. Sanitary sewer pipe shall be Polyvinyl Chloride (PVC) pipe, DR 35, as specified in the NMSS Section 121.
- 8. Manholes shall be constructed with precast reinforced concrete sections conforming to ASTM C-478. Block manholes are expressly prohibited. All portland cement concrete and mortar used in manhole construction shall utilize Type II cement. Care shall be taken to properly finish manhole inverts.
- 9. The water and sewer contractor shall complete his work, including trench compaction and clean—up, in any one street before the paving contractor starts final subgrade preparation for the street construction. Final adjustment to grade of valve boxes and manhole covers, pouring concrete collars, etc., shall be left for the paving contractor.
- 10. All watermains shall be chlorinated as specified in NMSS Section 801.17. Each service connection shall be operated to thoroughly flush the lines on completion.
- 11. All construction, including compaction, shall be guaranteed for a period of 12 months after completion of construction.
- 12. All service line connections for water and sewer shall be made with fittings specifically for the material used, and as per the manufacturer's installation requirements.

### NOTES — Water and Sewer Construction

- 1. Sewer services shall be located 5 feet <u>+</u> down—stream from the center of the lot frontage except where otherwise indicated on the plans. Opposing connections shall be spaced at least 4 feet apart along the sewer mains. Water services shall be located 5 feet <u>+</u> upstream from the common lot lines except where otherwise indicated on the plans, and 10 feet minimum away from the sewer services. Water taps shall be spaced at least 2 feet apart on the water mains.
- 2. Stationing is as shown on the plan and profile sheets.
- 3. Water mains shall not be located less than 10 feet away from sewer lines nor closer than 3 feet to the lip of the curb and gutter, except where lines cross.
- 4. Where a water line passes beneath or less than 18 inches above a sewer line, the sewer line shall be encased in concrete 6 inches thick as shown in the "Standard Details" for at least 10 feet on each side of the water line, or the sewer line shall be Ductile or Cast Iron Pipe with pressure—type joints for 10 feet on each side of the water line. This shall also apply where a parallel water line is less than 10 feet horizontally and less than 2 feet above the sewer.

### GENERAL NOTES:

- 1. Testing of construction materials, including subgrade compaction, shall be performed as required by the engineer and at the expense of the owner, except that the contractor shall pay for any re—testing required. The contractor shall cooperate in allowing opportunity for testing and furnishing samples and job site assistance as required. The contractor shall furnish manufacturer's certificates of quality as required.
- 2. The contractor shall maintain a reasonably clean job site throughout the construction period and at completion shall remove all debris and dress up all areas disturbed by his operations.
- 3. Measurement and payment of the various items of construction shall be made by the units indicated in the bid proposal and at the unit prices bid, work and materials not specifically called out in the bid proposal shall be considered incidental to the nearest associated item listed in the proposal.
- 4. The contractor shall do his own layout and construction staking from bench marks and and centerline reference points furnished by the owner. The contractor shall be responsible for properly referencing all triangulation stations, bench marks, monuments, and grant markers, section corners, or other permanent reference marker, that may be destroyed during the construction of this project. The Project Manager, at the contractor's expense, shall reference and reset destroyed monuments according to government regulations and state law. Design survey for Owner provided by John West Surveying Company.
- 5. Haul shall be considered incidental to construction, and no direct payment shall be made.
- 6. For estimating purposes only, earthwork quantities are based on a shrinkage factor of 0% in roadway embankment and 0% swell in roadway excavation.
- 7. No underground utilities (water or sewer) shall be backfilled prior to inspection and approval by the ENGINEER. Any backfill placed prior to inspection and approval will be removed at the contractor's expense.
- 8. Locations of all existing utilities shown were taken from record drawings or field surveys and are located as accurately as possible from information available. It will be the contractor's responsibilitity to protect, maintain in service, and at points required, verify exact locations of these utilities during construction operations of this project.
- 9. The contractor shall never unnecessarily interfere with or interrupt the services of any public utility having property within or adjacent to the construction area. He shall give all public utility companies a reasonable notice in writing, in no event less than 48 hours, for any work that he contemplates would interfere in any what whatsoever with the service of any existing public utility and city—owned facility.
- 10. When construction under this project connects to existing improvements the contractor shall build an easy—riding connection.
- 11. When abutting new pavement to edges of existing pavement, the existing pavement shall be cut a straight neat edge and tack coat shall be applied to edges of existing pavement prior to beginning of new pavement operations.
- 12. The Contractor shall coordinate any work required by others in the construction area with the construction of this project.
- 13. No underground utilities (water or sewer) shall be backfilled prior to inspection and approval by the CITY OF HOBBS. Any backfill placed prior to inspection and approval will be removed at the contractor's expense.
- 14. Where proposed elevations in the plans are shown with two digits preceeding the decimal, it shall be assumed that 3600 feet is to be added.
- 15. All concrete shall contain fiber reinforcement. Fiber reinforcement shall be virgin polypropylene strands approximately 3/4 inches in length, mixed into the concrete at a rate of 1.5 pounds per cubic yard or fibers shall be Anti-Crack HD (AR glass fibers) as manufactured by Saint-Gobain Vetrotex America and mixed into the concrete at a rate of 1.0 pounds per cubic yard (fiber length 3/4 inch). Use of fiber reinforcement does NOT substitute for any structural reinforcement required by teh project drawings and contract documents. No separate measurement or payment will be made for fiber reinforcement, it shall be considered incidental to to the item being installed.
- 16. Construction will not be considered complete until all drainage structures, including new curband gutter, are tested flowing and found satisfactory by the project manager. Finished concrete grade tolerance shall not deviate from those shown on the plans by more than =/- 0.002 feet. This shall be considered incidental to the construction of this project.

### MATERIAL SPECIFICATION:

Materials and equipment used in the installation of water and sewer improvements shall be in accordance with the City of Hobbs standards and shall be new and unused, manufactured in compliance with standards published by the American Society for Testing and Materials (ASTM), the Americal Water Works Association (AWWA) or other published applicable standards.

Where specific items are called for by name, make, or catalog number such reference shall be interpreted as establishing a standard quality and not construed as limiting competition. The use of substitutes is permissible in most cases, provided written requires and proper certification are submitted to the ENGINEER for review and approval prior to Bid Opening for City of Hobbs approval.

### SANITARY SEWER

Collector: PVC, SDR 26 (under 18" Dia.) (Stiffness of 46 for over 18" Dia.), push—on, gasketed (or glued) sewer pipe. Service: PVC, SCH 40 or SDR 21, push—on, gasketed (or glued) sewer pipe.

Fittings: PVC, SCH 40, push—on, gasketed sewer pipe,

Manholes: Fiberglass (preferred) or Precast reinforced concrete, 4 ft. inside diameter, type "C" Concentric manholes.

Manhole rim and Lid:

A. Vented in pavement areas, East Jordan Iron Works #41430120A01 or approved equal.

Frame & cover shall be AASHTO H-20 load rated, Ductile Iron castings shall be grade 70-50-05 conforming to ASTM A536 (latest edition), Grey Iron castings shall be CL35 conforming to ASTM A48 (latest edition), frame & cover to be uncoated. (See Details)

B. Sealing in drainage swale and bar-dich areas, shall be as required by the City of Hobbs.

Force Mains: HDPE DR 13.4 C-906 (WPR 130 psi) or PVC DR 14 Class 200 C-900 (WPR 145 psi).

POTABLE WATER

Distribution Lines: PVC, DR 18, Class 150, C-900 push-on, gasketed water pipe — OR — HDPE, DR 17, C-906 blue or blue stripe.

Fittings: Mechanical joint (MJ), class 250 or 350 S.S.B. type, ductile iron pipe fittings for PVC. Polyethylene fittings may be MJ or fused fittings, ductile iron pipe sizes. All HDPE pipe shall utilize MJ adapters when connection to Ductile Iron Fittings. Mega Lug restraned fittings shall be used along with concrete thrust blocking. Valves may be FL X MJ when connected at fittings.

Gate Valves: Mueller bonded resilient seat, non—raising stem type, mechanical joint, fuse bonded epoxy coated inside and out, 2 inch operating nut, opens counter—clockwise. Valves may be FL x MJ when connected at fittings.

Fire Hydrants: Kennedy Guardian — K81D Main valve fire hydrant, Exterior painted "chrome yellow" as per NM APWA specs. Valve Boxes: Tyler 461S, or equal

Water Meter Box — Regular Meter Box — EAst Jordan product number 32234002A04, round 18" x 18" and DFW Plastics Inc. plastic blue cover product number (18AMR-49).

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ALJO DEVELOPMENT,
TANGLEWOOD UNIT
GENERAL NOTES AN
MATERIALS SPECIFICAT

The ROSS
GROUP
CONSULTING ENGINEERS
410 N. DAL PASO
HOBBS, NEW MEXICO 88240

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SIZE

Drawn By: Checked by
PLR PLR
Date: Disk:
10-1-19 TANGLEWD
File Name: Job No.:
GEN NOTES

SHEET 2

of 19 shee

10.00' PERMANENT MUNICIPAL 10.00' PERMANENT MUNICIPAL INFRASTRUCTURE UTILITY EASEMENT-N89°18'55"E INFRASTRUCTURE UTILITY EASEMENT-CITY OF HOBBS CMU BUILDING (EAST) 5765.6 Sq. Ft. 6949.3 Sq. Ft. 6872.4 Sq. Ft. 10901.1 Sq. Ft. 13231.3 Sq. Ft. 8874.2 Sq. Ft. \_\_\_ \_\_118.00° \_\_\_ \_ √N89°22'20"E ── —N89°22'20"E — — 150.30'— — — —N89°19'10"E ⁻ <sup>-</sup>N89°22'20"E<sup>-</sup> 5591.4 Sq. Ft. 6844.0 Sq. Ft. 5506.4 Sq. Ft. 9586.1 Sq. Ft. 8352.0 Sq. Ft. -114.01'<del>-</del> ------- 118.00°-7892.3 Sq. Ft. 8614.0 Sq. Ft 8225.3 Sq. Ft. — -112.61'- <del></del> 7777.3 Sq. Ft. 10862.1 Sq. Ft. — 1 18.00'<sup>-</sup> 9280.0 Sq. Ft. 8325.6 Sq. Ft. — —116.00'— — 9104.2 Sq. Ft. 10384.0 Sq. Ft. 10384.0 Sq. Ft. 11040.5 Sq. Ft. \_\_\_\_116.85'\_\_\_\_ \_\_\_\_118.00'\_\_\_ 7424.0 Sq. Ft. \_ \_\_\_118.00'\_\_\_ \_\_\_ 7530.4 Sq. Ft. \_\_ \_\_\_155.50<sup>2</sup>— — — 9058.3 Sq. Ft. 7637.9 Sq. Ft. 7651.7 Sq. Ft. 10906.4 Sq. Ft. 8476.3 Sq. Ft. 8352.0 Sq. Ft. -1.00' UTILITY (TYP.) SEE NOTE #3 \_\_\_\_\_117.76'\_\_\_\_ N89°22'20"E 438.40' ROAD A2 N89°19'10"E 184.00' 80.00' 6 7538.5 Sq. Ft. 38.93' 7424.0 Sq. Ft. \_\_\_ <u>\_\_\_ 13</u>0.<u>50</u>′ \_\_\_ \_\_ — —116 00'— — – 12305.9 Sq. Ft. 9428.4 Sq. Ft. 9280.0 Sq. Ft. \_\_\_\_ \_\_\_\_155.50'\_\_\_ \_\_\_ \_\_\_\_ 80 00° \_\_\_ 12440.0 Sq. Ft. 11637.7 Sq. Ft. -1.00' UTILITY (TYP.) -1.00' UTILITY (TYP.) SEE NOTE #3 153.78' \_\_\_\_ -130.02'- \_\_\_\_ SEE NOTE #3 438.75° — N89°19'10"E— N89°22'20"E 729.78' —1.00' UTILITY (TYP., TANGLEWOOD AVENUE SEE NOTE #3 38.54 70.00' 80.00' 56.00' 70.00 68.00° 60.00' 12778.0 Sq. Ft. N°22'20"E N00°43'48"W-N89°19'10"E 2nd UNIT TAYLOR ESTATES ADDITION ALBERTSON DRIVE SURVEYOR'S CERTIFICATE: I, GARY G. EIDSON, NEW MEXICO PROFESSIONAL SURVEYOR No. 12641, DO HEREBY CERTIFY THAT THIS SURVEY PLAT AND THE ACTUAL SURVEY ON THE GROUND UPON WHICH IT IS BASED WERE PERFORMED BY ME OR UNDER MY DIRECT SUPERVISION; THAT I AM RESPONSIBLE FOR THIS SURVEY; THAT THIS SURVEY MEETS THE MINIMUM STANDARDS FOR SURVEYING IN NEW MEXICO; AND THAT IT IS TRUE AND CORRECT TO THE BEST OF MY KNOWLEDGE AND BELIEF.

GARY G. EIDSON \_\_\_\_\_


PROVIDING SURVEYING SERVICES

JOHN WEST SURVEYING COMPANY 412 N. DAL PASO HOBBS, N.M. 88240

> (575) 393-3117 www.jwsc.biz TBPLS# 10021000

TRACT 3 (REMAINDER), LEDGESTONE SUBDIVISION #3

GLORIETTA DRIVE EXTENSION (FUTURE)

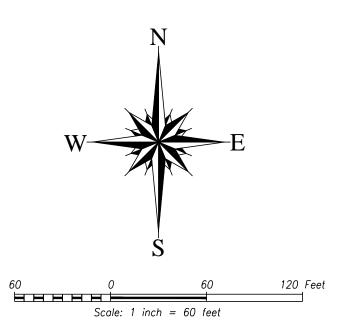

### LEGEND:

- • - DENOTES SET 1/2" STEEL ROD W/CAP MARKED "JWSC PS 12641"
- - DENOTES FOUND 5/8" STEEL ROD
- DENOTES DIMENSION POINT
- —— — DENOTES BUILDING SETBACK LINE (SEE NOTE #2)

----- - DENOTES CENTERLINE OF ROADWAY

1) BEARINGS SHOWN HEREON ARE MERCATOR GRID AND CONFORM TO THE NEW MEXICO COORDINATE SYSTEM "NEW MEXICO EAST ZONE" NORTH AMERICAN DATUM 1983. DISTANCES ARE SURFACE VALUES.

2) LOT SIDE AND REAR SETBACK LINES ARE 5.0 FEET EXCEPT ALONG RIGHTS-OF-WAY, WHERE 10.00 FOOT SIDE SETBACK LINES APPLY. LOT FRONT SETBACK LINES ARE 21.00 FEET.

3) A TWO FOOT UTILITY & FENCE EASEMENT IS HEREBY RESERVED ALONG LOT LÍNES ADJOINING THE NORTH LINE OF THIS SUBDIVISION PARCEL. A ONE FOOT EASEMENT IS HEREBY RESERVED AROUND AND WITHIN ALL OTHER LOTS ADJOINING RIGHTS-OF-WAY. ALL RIGHTS-OF-WAY ARE DEDICATED THIS PLAT.

4) WITH RESPECT TO THE FLOOD INSURANCE RATE MAP FOR LEA COUNTY, NEW MEXICO AND INCORPORATED AREAS, PANEL 1355 OF 2150, MAP No. 35025C1355D, EFFECTIVE DATE, DECEMBER 16, 2008. THE ABOVE DESCRIBED PROPERTY LOCATED IN THE SOUTH HALF OF SECTION 23. TOWNSHIP 18 SOUTH, RANGE 38 EAST. N.M.P.M., CITY OF HOBBS, LEA COUNTY, NEW MEXICO, IS LOCATED IN ZONE D BEING DEFINED AS AREAS IN WHICH FLOOD HAZARDS ARE UNDETERMINED, BUT

			CURVE TABI	L <b>E</b>	
C1	25.00'	39.27'	90°00′00.00″	35.36'	S45°40'50
C2	25.00'	20.54	47°04'12"	19.97'	S22°51'16
C3	54.00'	13.69	14°31'17"	13.65	N39°07'43
C4	54.00'	78.71	83°31'02"	71.93'	S09°53'26
C5	54.00'	36.79	39°01'53"	36.08'	S71°09'53
C6	54.00'	43.19'	45°49'44"	42.05	N66°24'18
C7	54.00'	86.56	91°50'48"	77.59	N02°25'58
C8	25.00'	4.67'	10°42'13"	4.66'	S43°00'16
C8A	25.00'	16.13'	36°58'19"	15.85	N19°10'00
C9	25.00'	39.29'	90°03'10.21"	35.37'	N44°20'45
C10	25.00'	39.27'	90°00'00.00"	35.36'	S45°37'40
C11	25.00'	39.25'	89°56'35.00"	35.34'	S44°20'37
C12	25.00'	39.29'	90°03'25.00"	35.37'	N45°39'22
C13	25.00'	39.27'	90°00'00.00"	35.36'	N44°22'20
C14	25.00'	39.27'	90°00'00.00"	35.36'	S45°37'40
C15	25.00'	20.67	47°22'24.93"	20.09	S23°03'32
C16	54.00'	25.54	27°06'06.95"	25.31'	N33°11'41
C17	54.00'	63.09'	66°56'11.67"	59.56'	N13°49'28
C18	54.00'	40.84	43°20'06.31"	39.88'	N68°57'37
C19	54.00'	40.95	43°26'56.31"	39.98'	S67°38'52
C20	54.00'	63.09'	66°56'11.67"	59.56	S12°27'18
C21	54.00'	25.44	26°59'16.95"	25.20'	S34°30'26
C22	25.00'	20.67'	47°22'24.93"	20.09'	N24°18'52
C23	25.00'	39.27'	90°00'00.00"	35.36'	N44°22'20
C24	25.00'	39.27'	90°00'00.00"	35.36'	N45°37'40
C25	25.00'	39.27'	90°00'00.00"	35.36'	N44°22'20
C26	25.00'	39.27'	90°00'00.00"	35.36'	N45°37'40
C27	25.00'	39.27'	90°00'00.00"	35.36'	S44°22'20
C28	20.00'	17.12'	49°02'58.57"	16.60'	N66°06'11
C29	54.00'	49.96'	53°00'16.95"	48.19	S68°04'50
C30	54.00'	42.57'	45°10'09.00"	41.48'	N62°49'57
C31	54.00'	40.03'	42°28'17.15"	39.12'	N19°00'44
C32	54.00'	44.77	47°30'24.25"	43.50'	N25°58'37
C33	20.00'	17.12'	49°02'58.57"	16.60'	S25°12'19
C34	25.00'	39.27'	90°00'00.00"	35.36	S44°19'10

### TANGLEWOOD UNIT FOUR

AT RANCHVIEW ESTATES SUBDIVISION TO THE CITY OF HOBBS, LEA COUNTY, NEW MEXICO LOCATED IN THE IN THE SOUTH HALF OF SECTION 23,

TOWNSHIP 18 SOUTH, RANGE 38 EAST, N.M.P.M., CITY OF HOBBS, LEA COUNTY, NEW MEXICO

### OWNER'S STATEMENT, DEDICATION AND AFFIDAVIT:

THE FOREGOING SUBDIVISION OF TRACT 11, AS SHOWN ON THAT CERTAIN PLAT RECORDED ON MARCH 12, 2019, IN CABINET F, SLIDE 109 AND IN SURVEY RECORDS BOOK 2, PAGE 557 OF THE OFFICIAL RECORDS OF LEA COUNTY, NEW MEXICO AND SITUATED WITHIN THE CORPORATE BOUNDARIES OF THE CITY OF HOBBS, LEA COUNTY, NEW MEXICO, LOCATED IN THE SOUTH HALF OF SECTION 23 AND THE SOUTHWEST QUARTER OF SECTION 24, TOWNSHIP 18 SOUTH, RANGE 38 EAST, N.M.P.M., AND BEING MORE PARTICULARLY DESCRIBED AS FOLLOWS;

BEGINNING AT A 1/2" STEEL ROD WITH CAP MARKED "JWSC PS 12641" FOUND AT THE NORTHWEST CORNER OF TANGLEWOOD UNIT THREE AT RANCHVIEW ESTATES SUBDIVISION TO THE CITY OF HOBBS, LEA COUNTY, NEW MEXICO, AS SHOWN ON SAID PLAT RECORDED IN BOOK 2152 ON PAGE 92 OF THE OFFICIAL RECORDS OF LEA COUNTY, NEW MEXICO, FOR THE NORTHEAST CORNER OF THIS TRACT; THEN SO0°40'50"E ALONG THE WEST LINE OF SAID TANGLEWOOD UNIT THREE A DISTANCE OF 815.42 FEET TO A 1/2" STEEL ROD WITH CAP MARKED "JWSC PS 12641" FOUND FOR THE SOUTHEAST CORNER OF THIS TRACT; THEN S89'19'10"W A DISTANCE OF 159.80 FEET TO A 1/2" STEEL ROD WITH CAP MARKED "JWSC PS 12641" SET FOR A CORNER OF THIS TRACT; THEN NOO 43'48"W A DISTANCE OF 13.02 FEET TO A 1/2" STEEL ROD WITH CAP MARKED "JWSC PS 12641" FOUND FOR A CORNER OF THIS TRACT; THEN S89°22'20"W ALONG THE NORTH LINE OF THE SECOND UNIT OF THE TAYLOR ESTATES ADDITION TO THE CITY OF HOBBS A DISTANCE OF 1651.59 FEET TO A 1/2" STEEL ROD WITH CAP MARKED "JWSC PS 12641" FOUND FOR A POINT ON THE EAST LINE OF A TRACT OF LAND CONVEYED TO THE HOBBS MUNICIPAL SCHOOLS DISTRICT No. 16 (HMS No. 16) BY WARRANTY DEED RECORDED IN BOOK 276, PAGE 124, OF THE OFFICIAL RECORDS OF LEA COUNTY, NEW MEXICO AND A CORNER OF THIS TRACT; THEN NOO'43'21"W A DISTANCE OF 285.00 FEET TO A 1/2" STEEL ROD WITH CAP MARKED "JWSC PS 12641" FOUND FOR A CORNER OF THIS TRACT; THEN N89°22'20"E A DISTANCE OF 15.90 FEET TO A 1/2" STEEL ROD WITH CAP MARKED "JWSC PS 12641" SET FOR A CORNER OF THIS TRACT; THEN NO0'43'21"W A DISTANCE OF 515.76 FEET TO A 1/2" STEEL ROD WITH CAP MARKED "JWSC PS 12641" SET FOR THE NORTHWEST CORNER OF THIS TRACT; THEN N89'18'55"E A DISTANCE OF 1796.09 FEET TO TO THE POINT OF BEGINNING.

LESS AND EXCEPT A TRACT OF LAND LOCATED IN THE NORTHEAST QUARTER OF THE SOUTHEAST QUARTER OF SECTION 23, TOWNSHIP 18 SOUTH, RANGE 38 EAST, N.M.P.M., MORE PARTICULARLY DESCRIBED AS FOLLOWS: BEGINNING AT A POINT WHICH LIES N89°22'20"E 4315.96 FEET AND N00°43'48"W 2612.21 FEET FROM THE SOUTHWEST CORNER OF SAID SECTION 23; THEN NOO°43'48"W 40.00 FEET; THEN N89°22'20"E 40.00 FEET; THEN SOO'43'48"E 40.00 FEET; THEN S89'22'20"W 40.00 FEET TO THE POINT OF BEGINNING, LEAVING TRACT 11 WITH 33.16 ACRES MORE OR LESS.

SAID PROPERTY IS BEING SUBDIVIDED AS THE SAME APPEARS HEREON, WITH ALL RIGHTS-OF-WAY AS SHOWN BEING DEDICATED TO THE PUBLIC, COMPRISING TANGLEWOOD, UNIT THREE, AT RANCHVIEW ESTATES, TO THE CITY OF HOBBS, WITH THE FREE CONSENT AND IN ACCORDANCE WITH THE DESIRES OF THE UNDERSIGNED OWNER AND PROPRIETORS THEREOF, NOTICE IS HEREBY GIVEN THAT THERE HAS BEEN FILED IN THE OFFICE OF THE COUNTY CLERK OF LEA COUNTY, NEW MEXICO, CERTAIN RESTRICTIVE COVENANTS APPLICABLE TO THE ABOVE DESCRIBED PROPERTY, WHICH SAID COVENANTS ARE RECORDED ON PAGE \_\_\_\_\_ OF BOOK \_\_\_\_\_, MISCELLANEOUS RECORDS OF SAID COUNTY.

OWNER: ADALBERTO CABALLERO ALJO DEVELOPMENT LLC

### **ACKNOWLEDGMENT**

STATE OF NEW MEXICO COUNTY OF LEA

THIS INSTRUMENT WAS ACKNOWLEDGED BEFORE ME THIS \_\_\_\_\_ DAY OF \_\_\_\_\_, 2019 A.D., BY ADALBERTO CABALLERO, ALJO DEVELOPMENT LLC.

NOTARY PUBLIC

MY COMMISSION EXPIRES

### CERTIFICATE OF MUNICIPAL APPROVAL

I, JAN FLETCHER, THE DULY APPOINTED AND ACTING CITY CLERK OF THE CITY OF HOBBS, LEA COUNTY, NEW MEXICO, DO HEREBY CERTIFY THAT THE FOREGOING PLAT OF TANGLEWOOD UNIT FOUR AT RANCHVIEW ESTATES SUBDIVISION, WAS APPROVED BY THE COMMISSION OF THE CITY OF HOBBS BY RESOLUTION No. \_\_\_\_\_, 2019 A.D.

JAN FLETCHER, CITY CLERK

**ACKNOWLEDGMENT:** 

STATE OF NEW MEXICO COUNTY OF LEA

THIS INSTRUMENT WAS ACKNOWLEDGED BEFORE ME THIS \_\_\_\_ DAY OF \_\_\_\_, 2019 A.D., BY JAN FLETCHER.

NOTARY PUBLIC

MY COMMISSION EXPIRES

### CERTIFICATE OF APPROVAL BY THE CITY PLANNING BOARD:

THE PLAT, RESTRICTIONS AND DEDICATION REVIEWED AND APPROVED ON THE \_\_\_\_ DAY OF \_\_\_\_\_, 2019 A.D., BY THE CITY PLANNING BOARD OF HOBBS, NEW MEXICO.


CHAIRMAN: WILLIAM M. HICKS III **ACKNOWLEDGMENT:** 

STATE OF NEW MEXICO COUNTY OF LEA

THIS INSTRUMENT WAS ACKNOWLEDGED BEFORE ME THIS \_\_\_\_\_ DAY OF \_\_\_\_\_, 2019 A.D., BY WILLIAM M. HICKS III.

NOTARY PUBLIC

MY COMMISSION EXPIRES

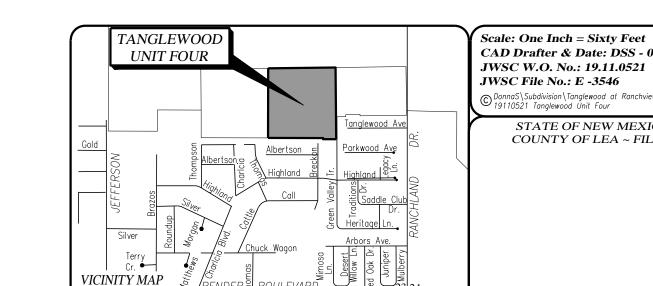

CAD Drafter & Date: DSS - 07/23/19 JWSC W.O. No.: 19.11.0521 JWSC File No.: E -3546 © DonnaS\Subdivision\Tanglewood at Ranchview Estates\ 19110521 Tanglewood Unit Four

> STATE OF NEW MEXICO COUNTY OF LEA ~ FILED:


PRELIMINARY - 09/25/19 REVIEW PURPOSES ONLY


 $\mathrel{\sqsubseteq}_{1.00}$ ' UTILITY (TYP.)


HIGHWOOD AVENUE


SEE NOTE #3


13825.8 Sq. Ft.

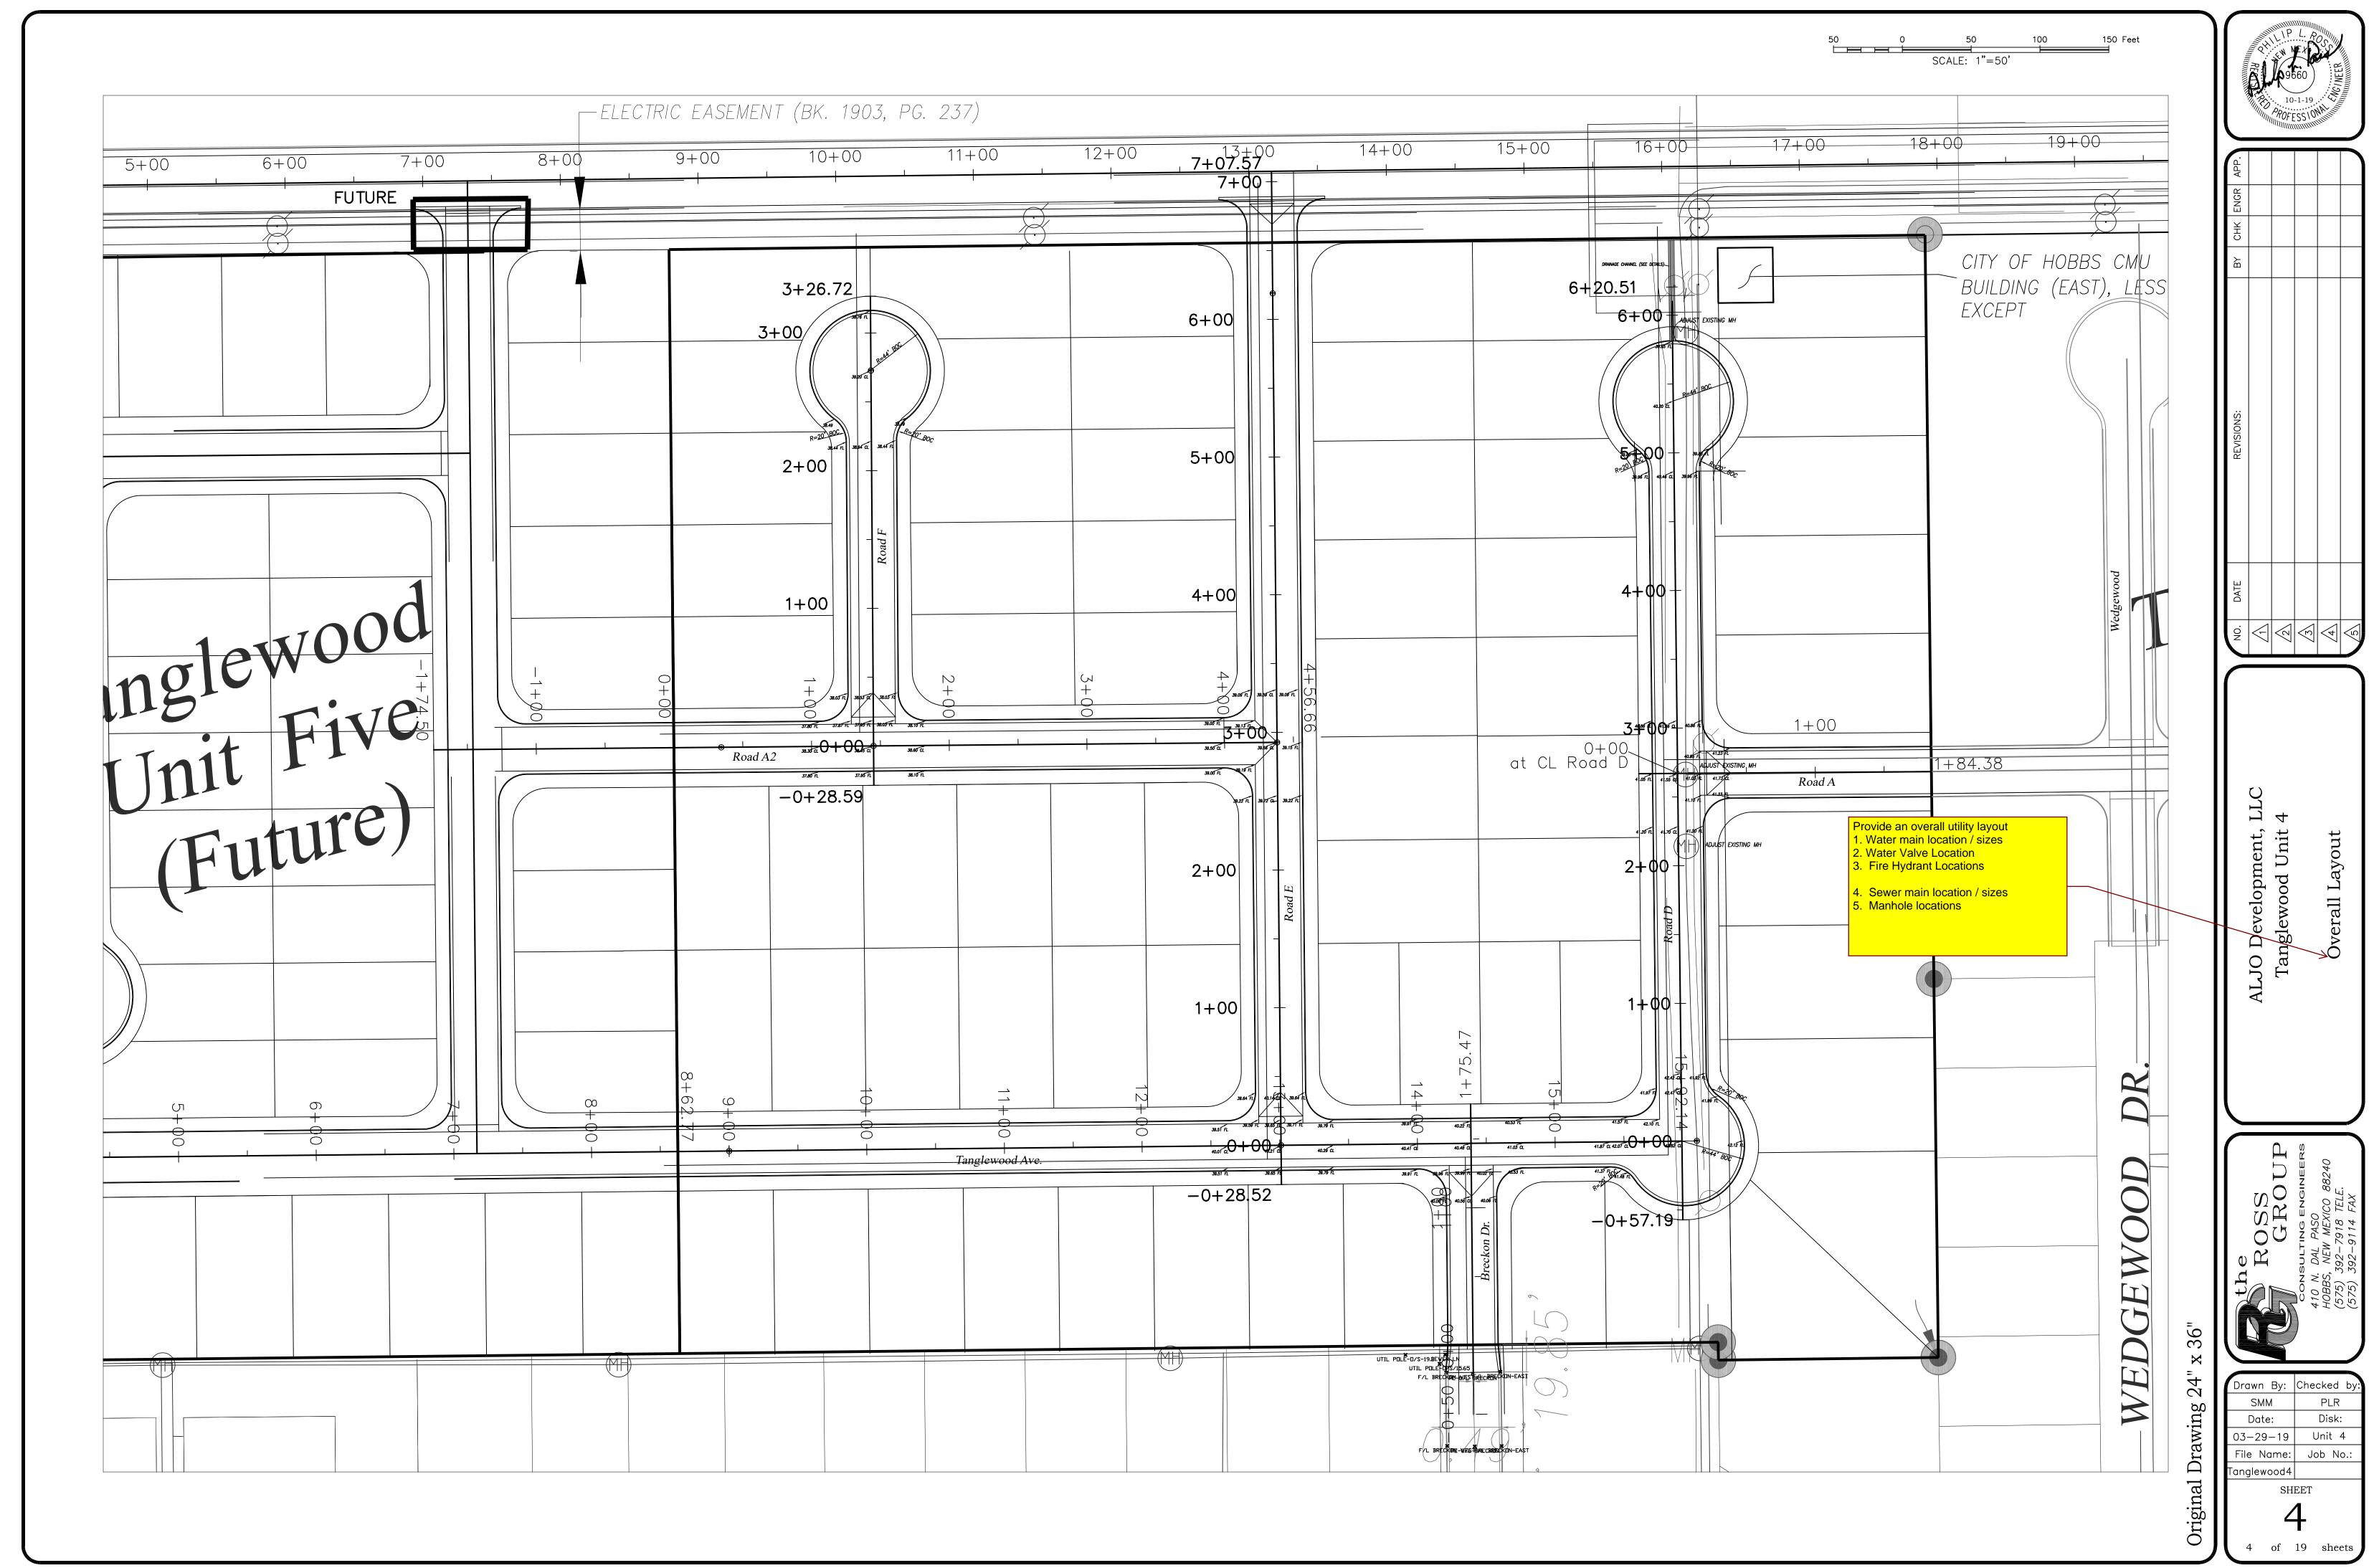


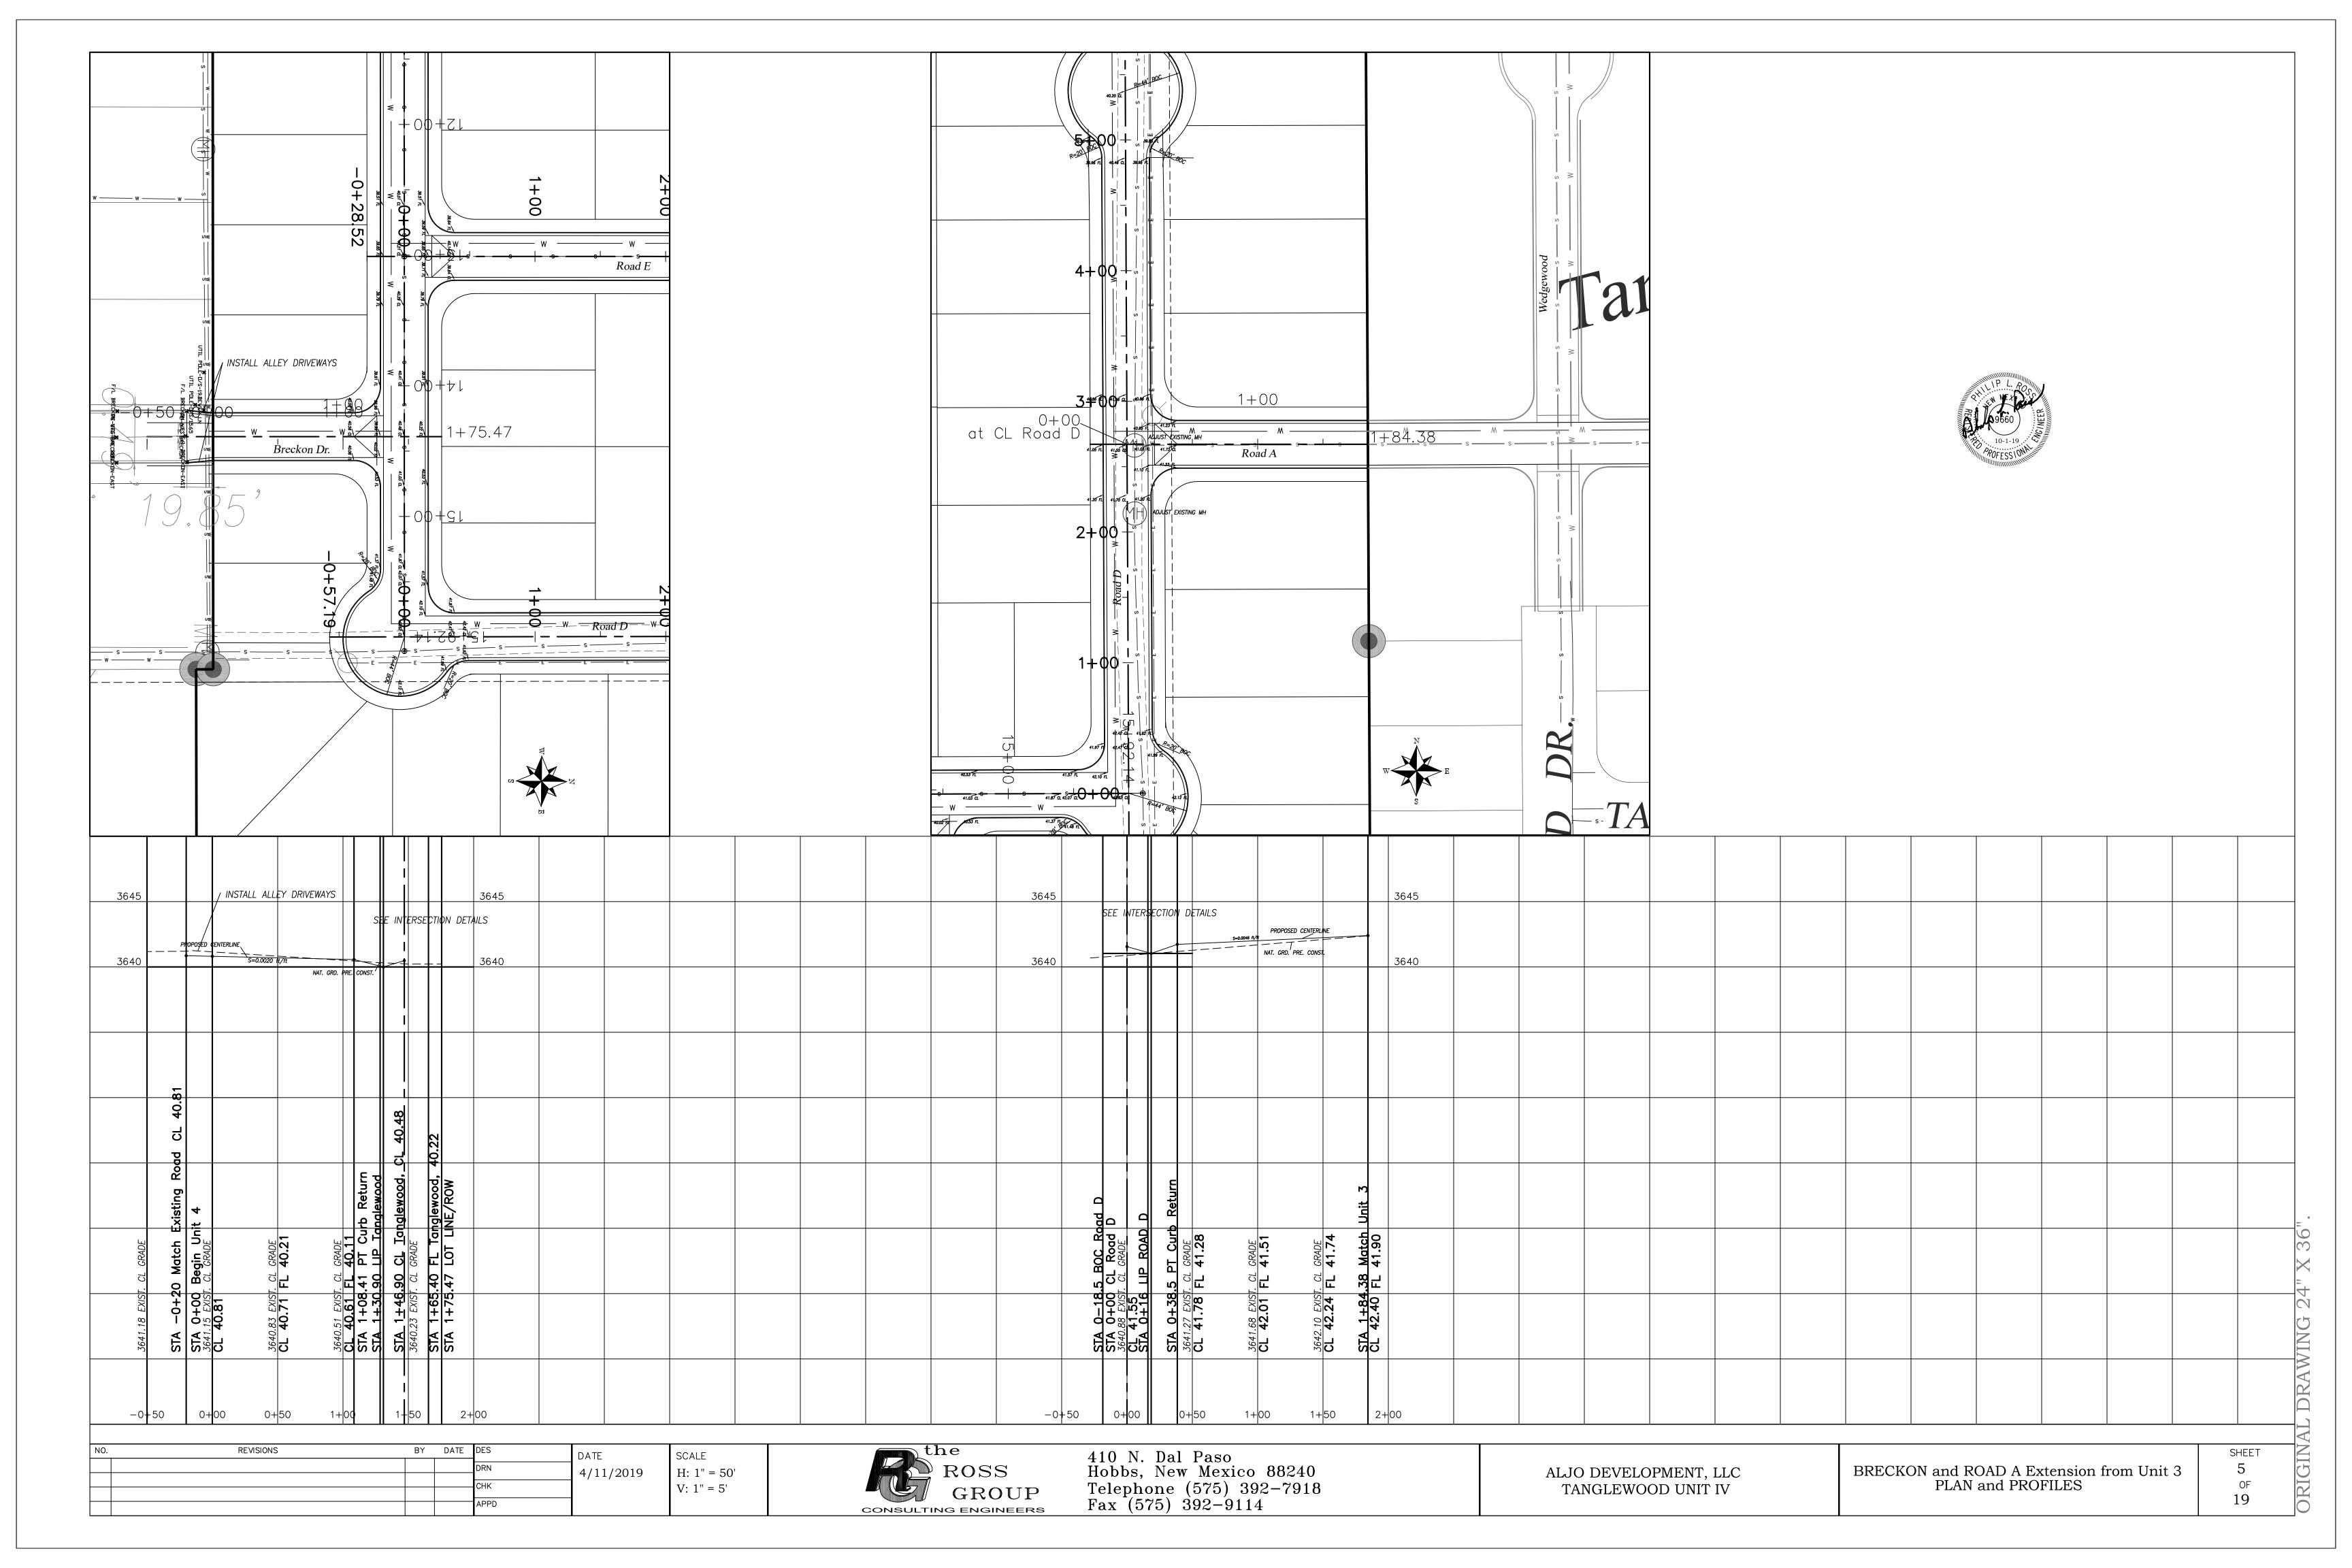


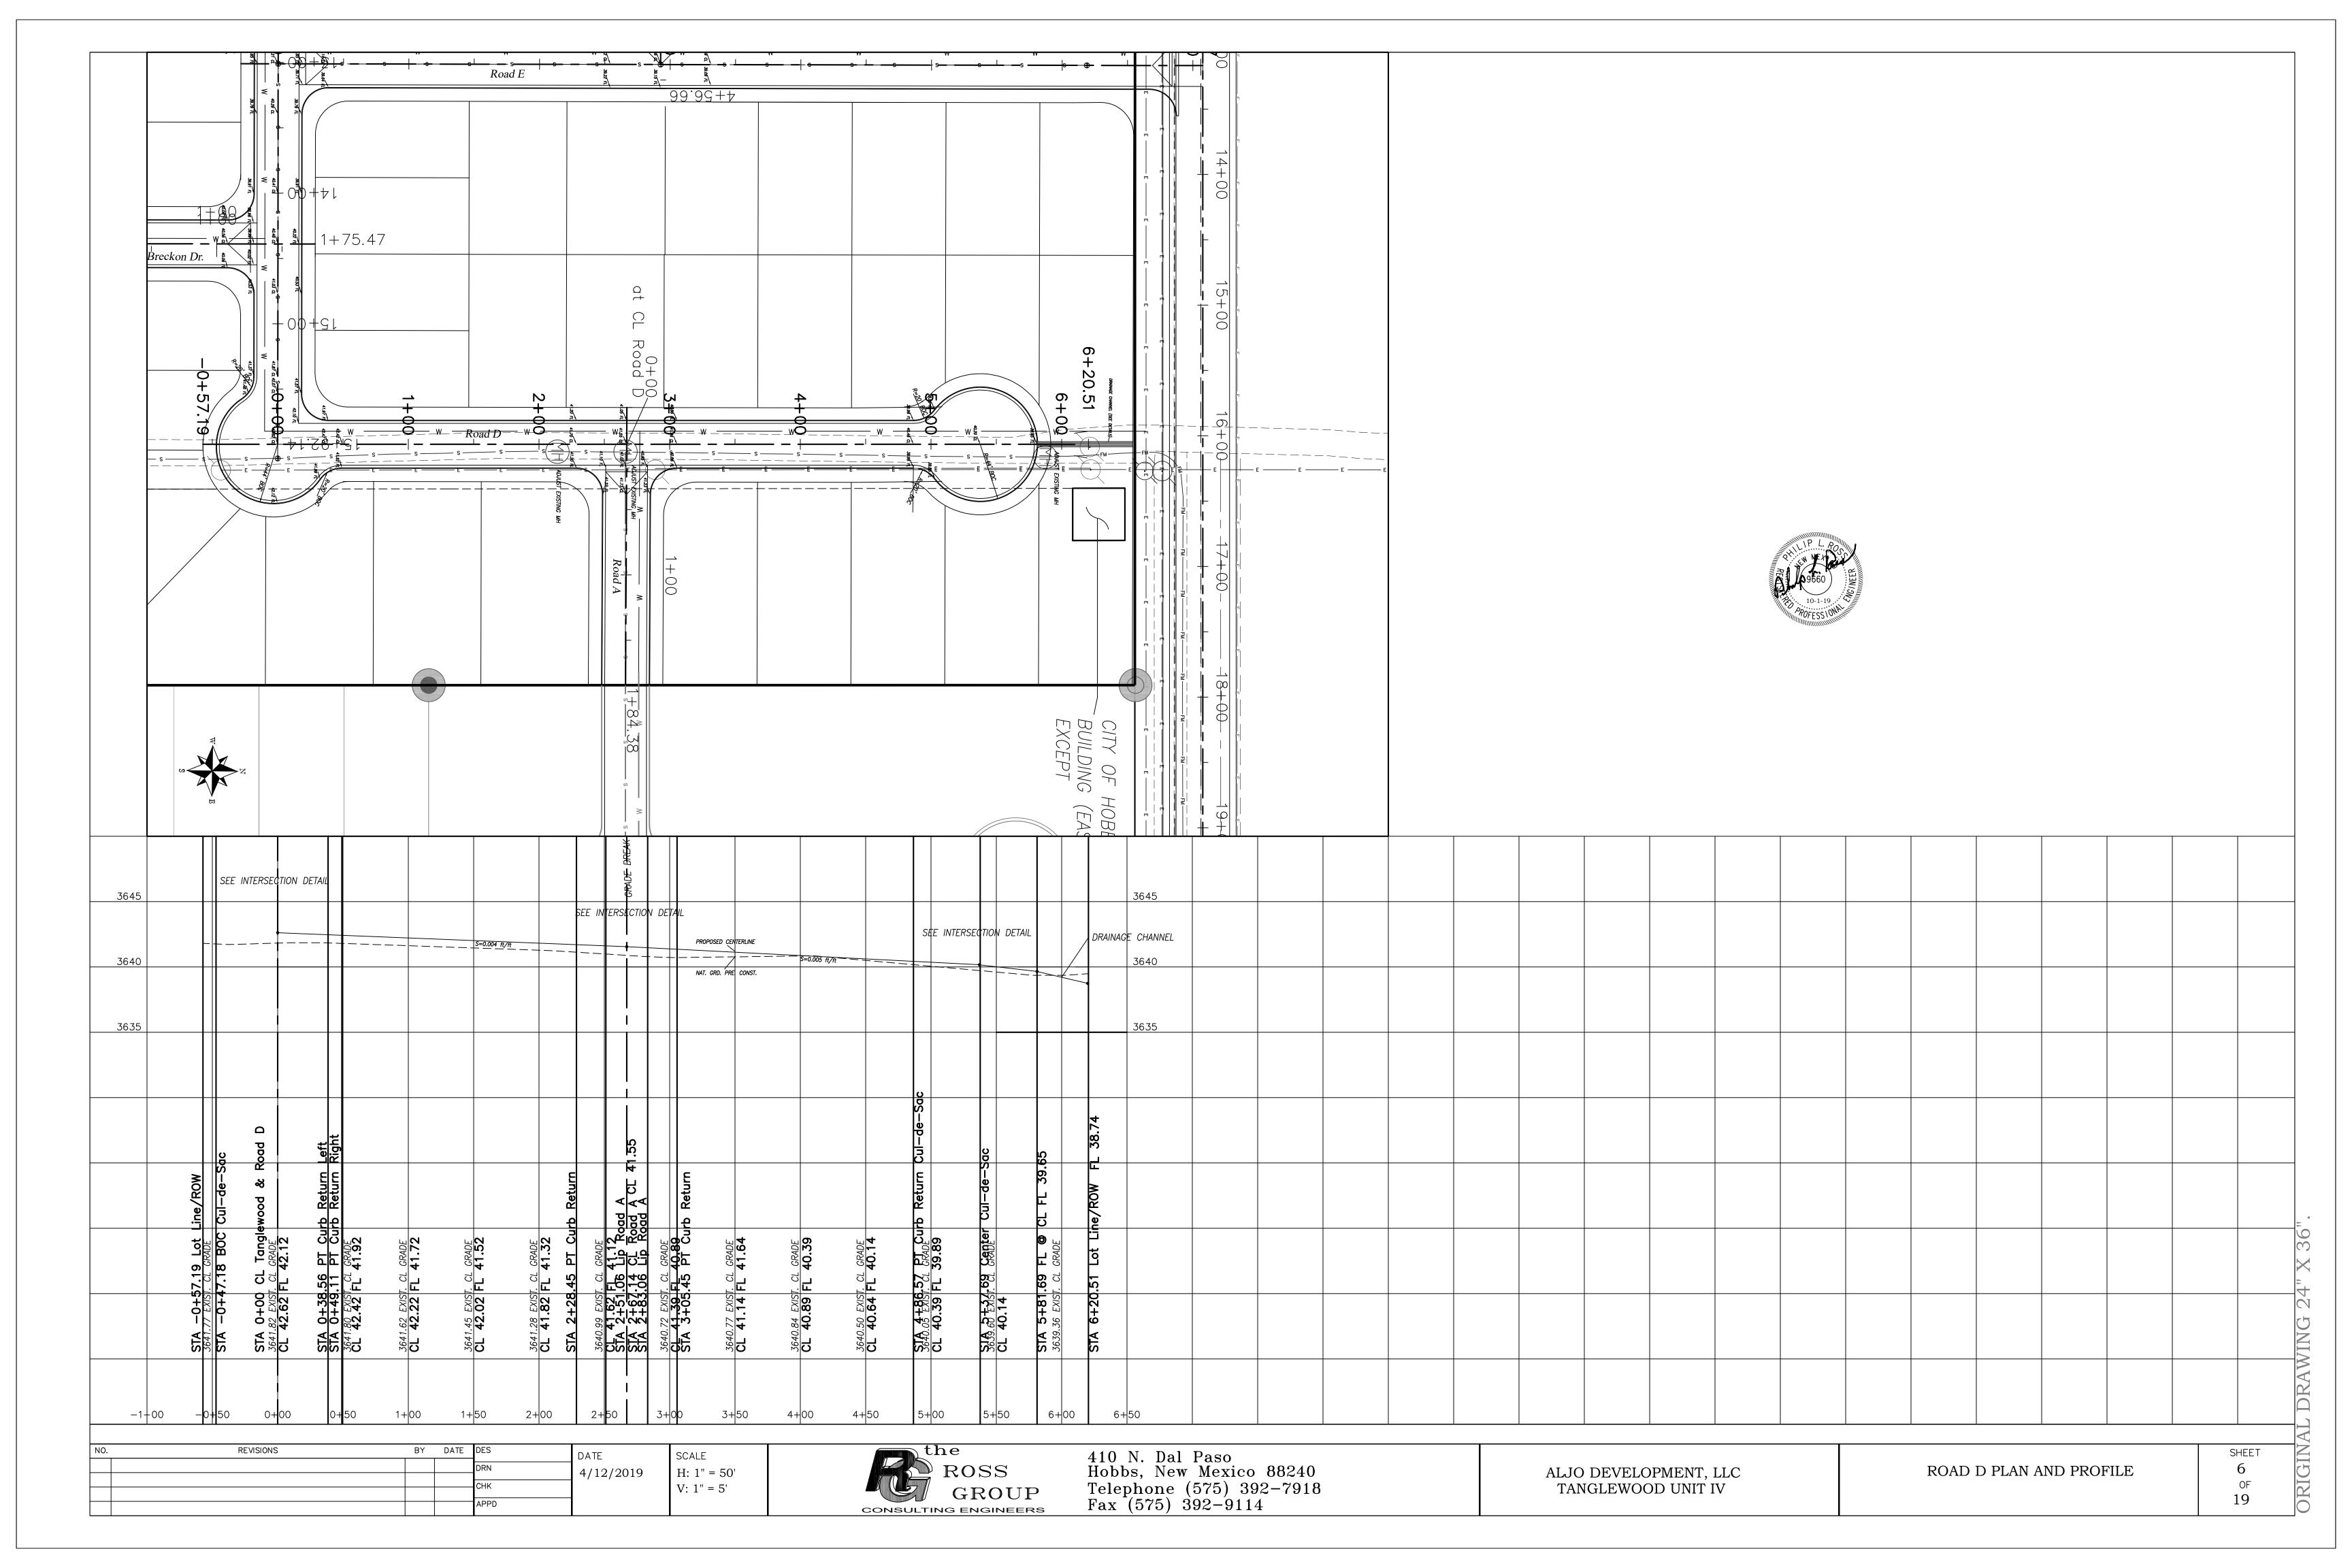


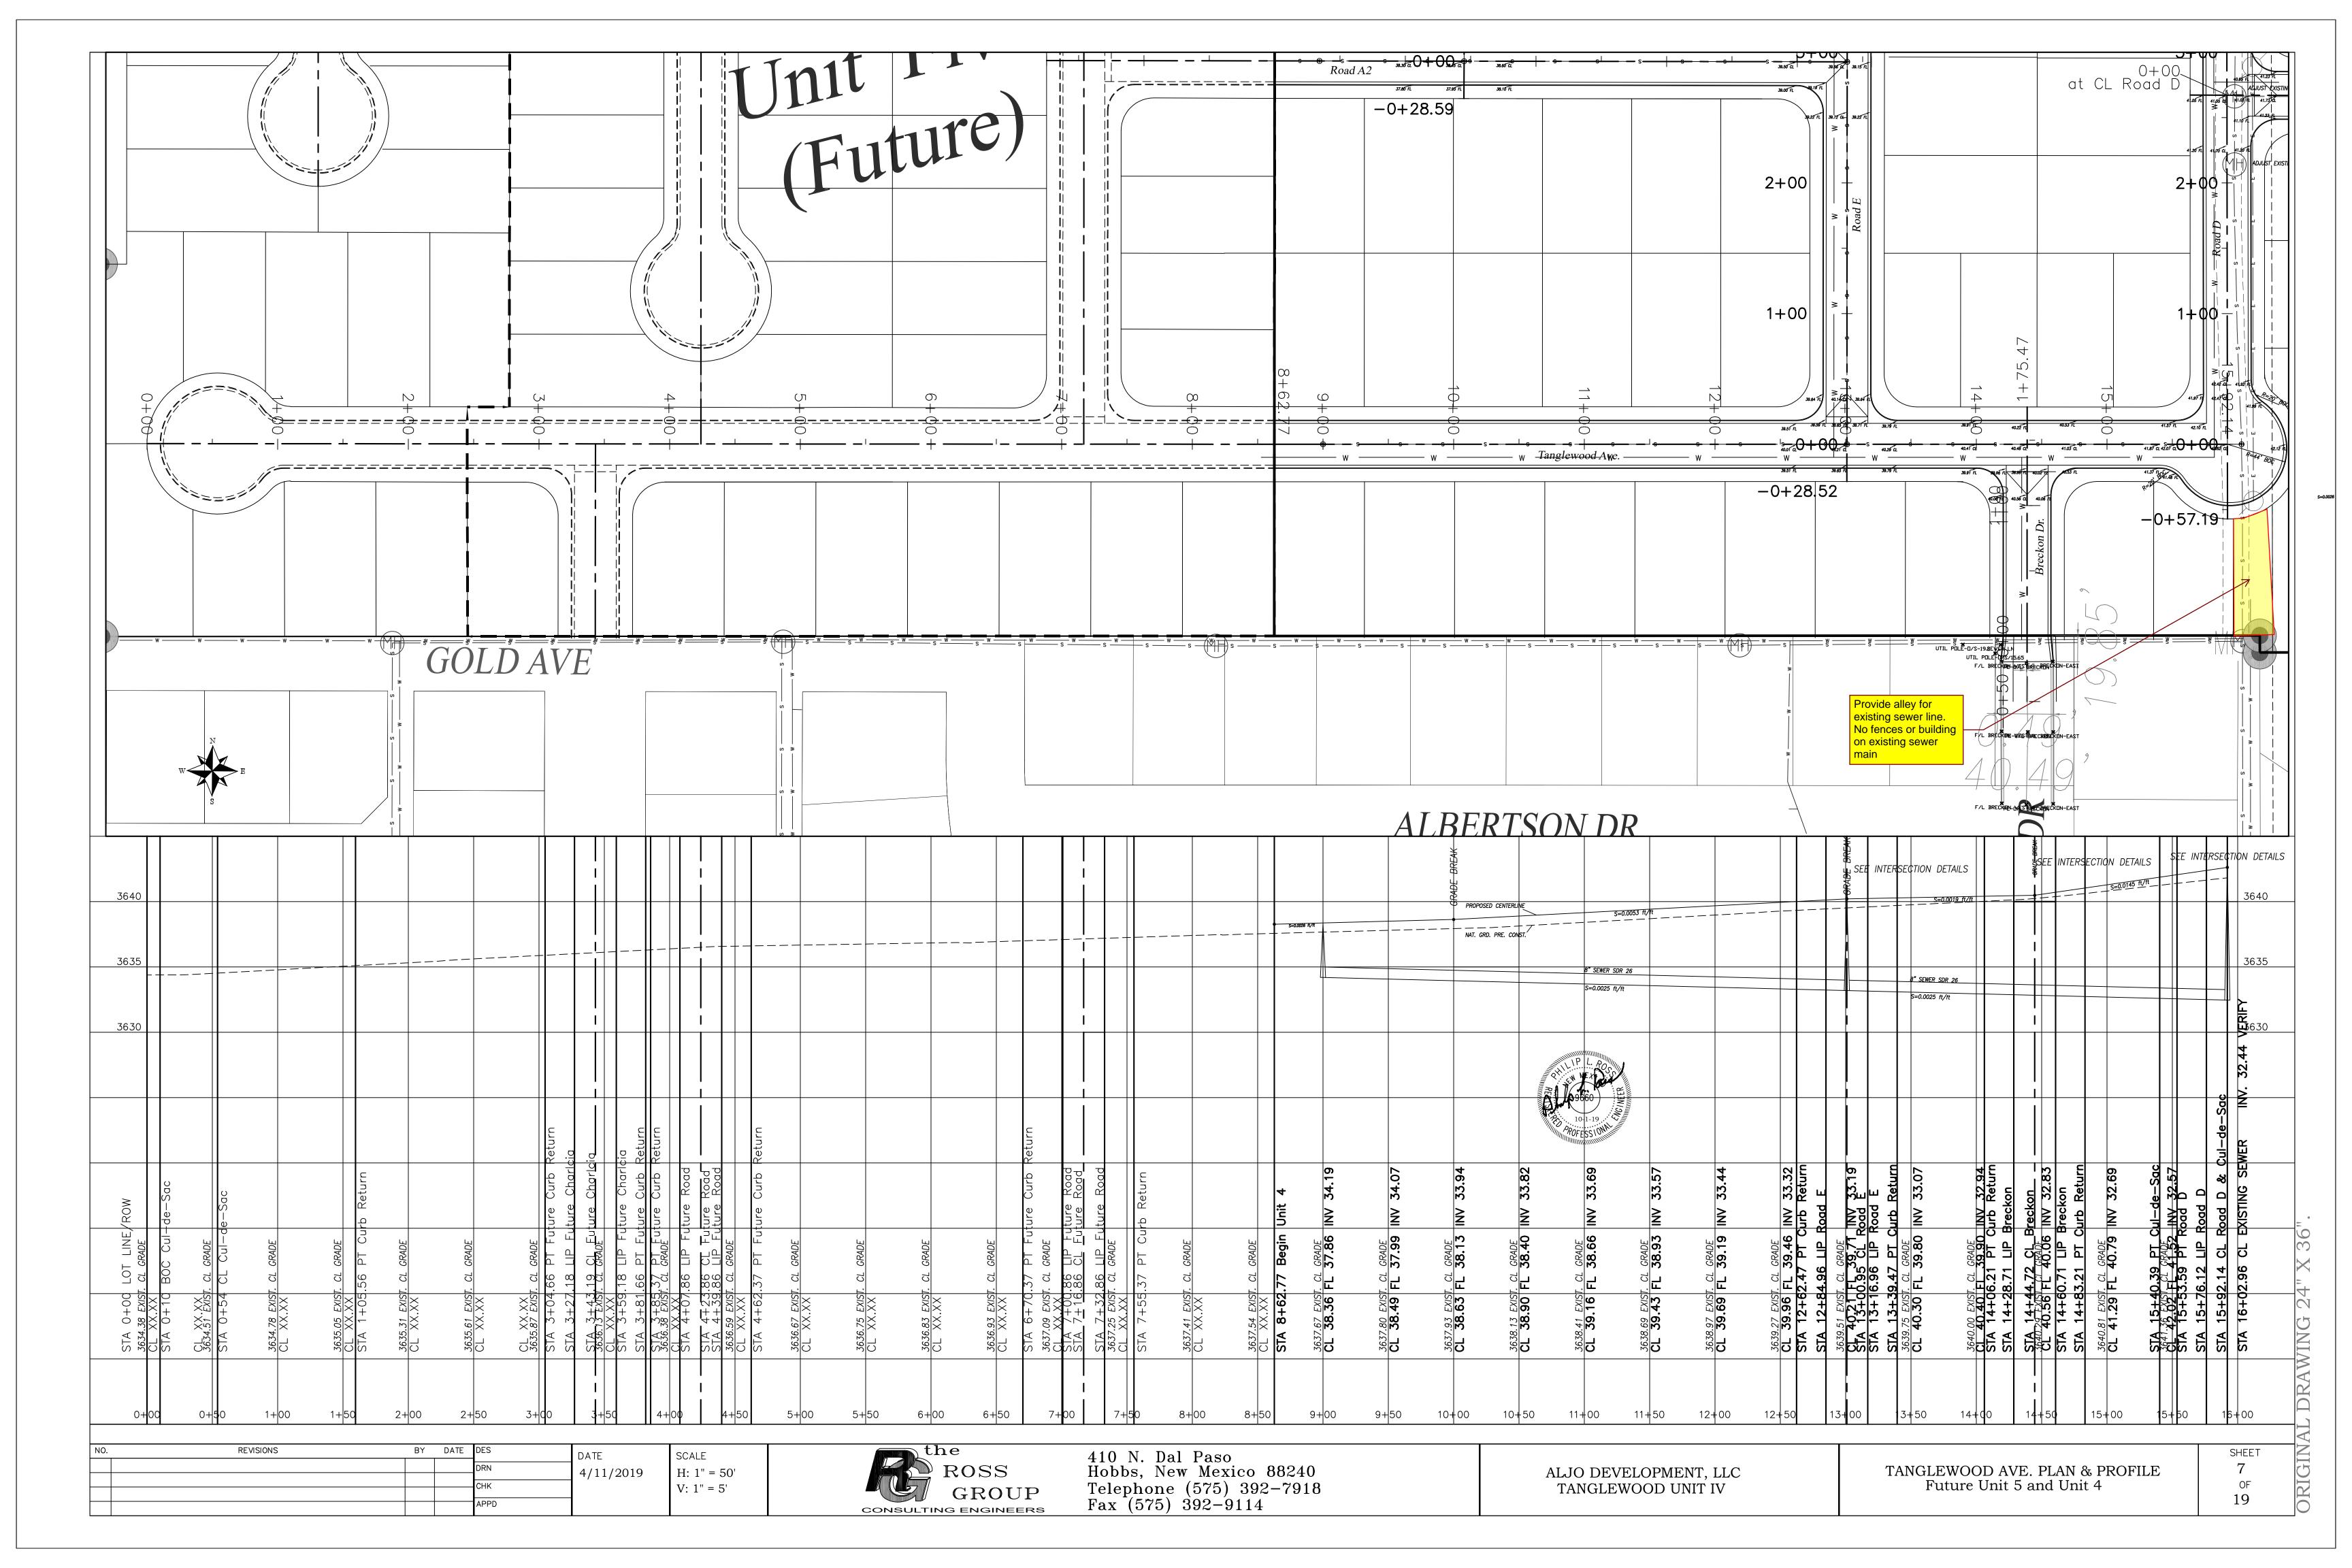


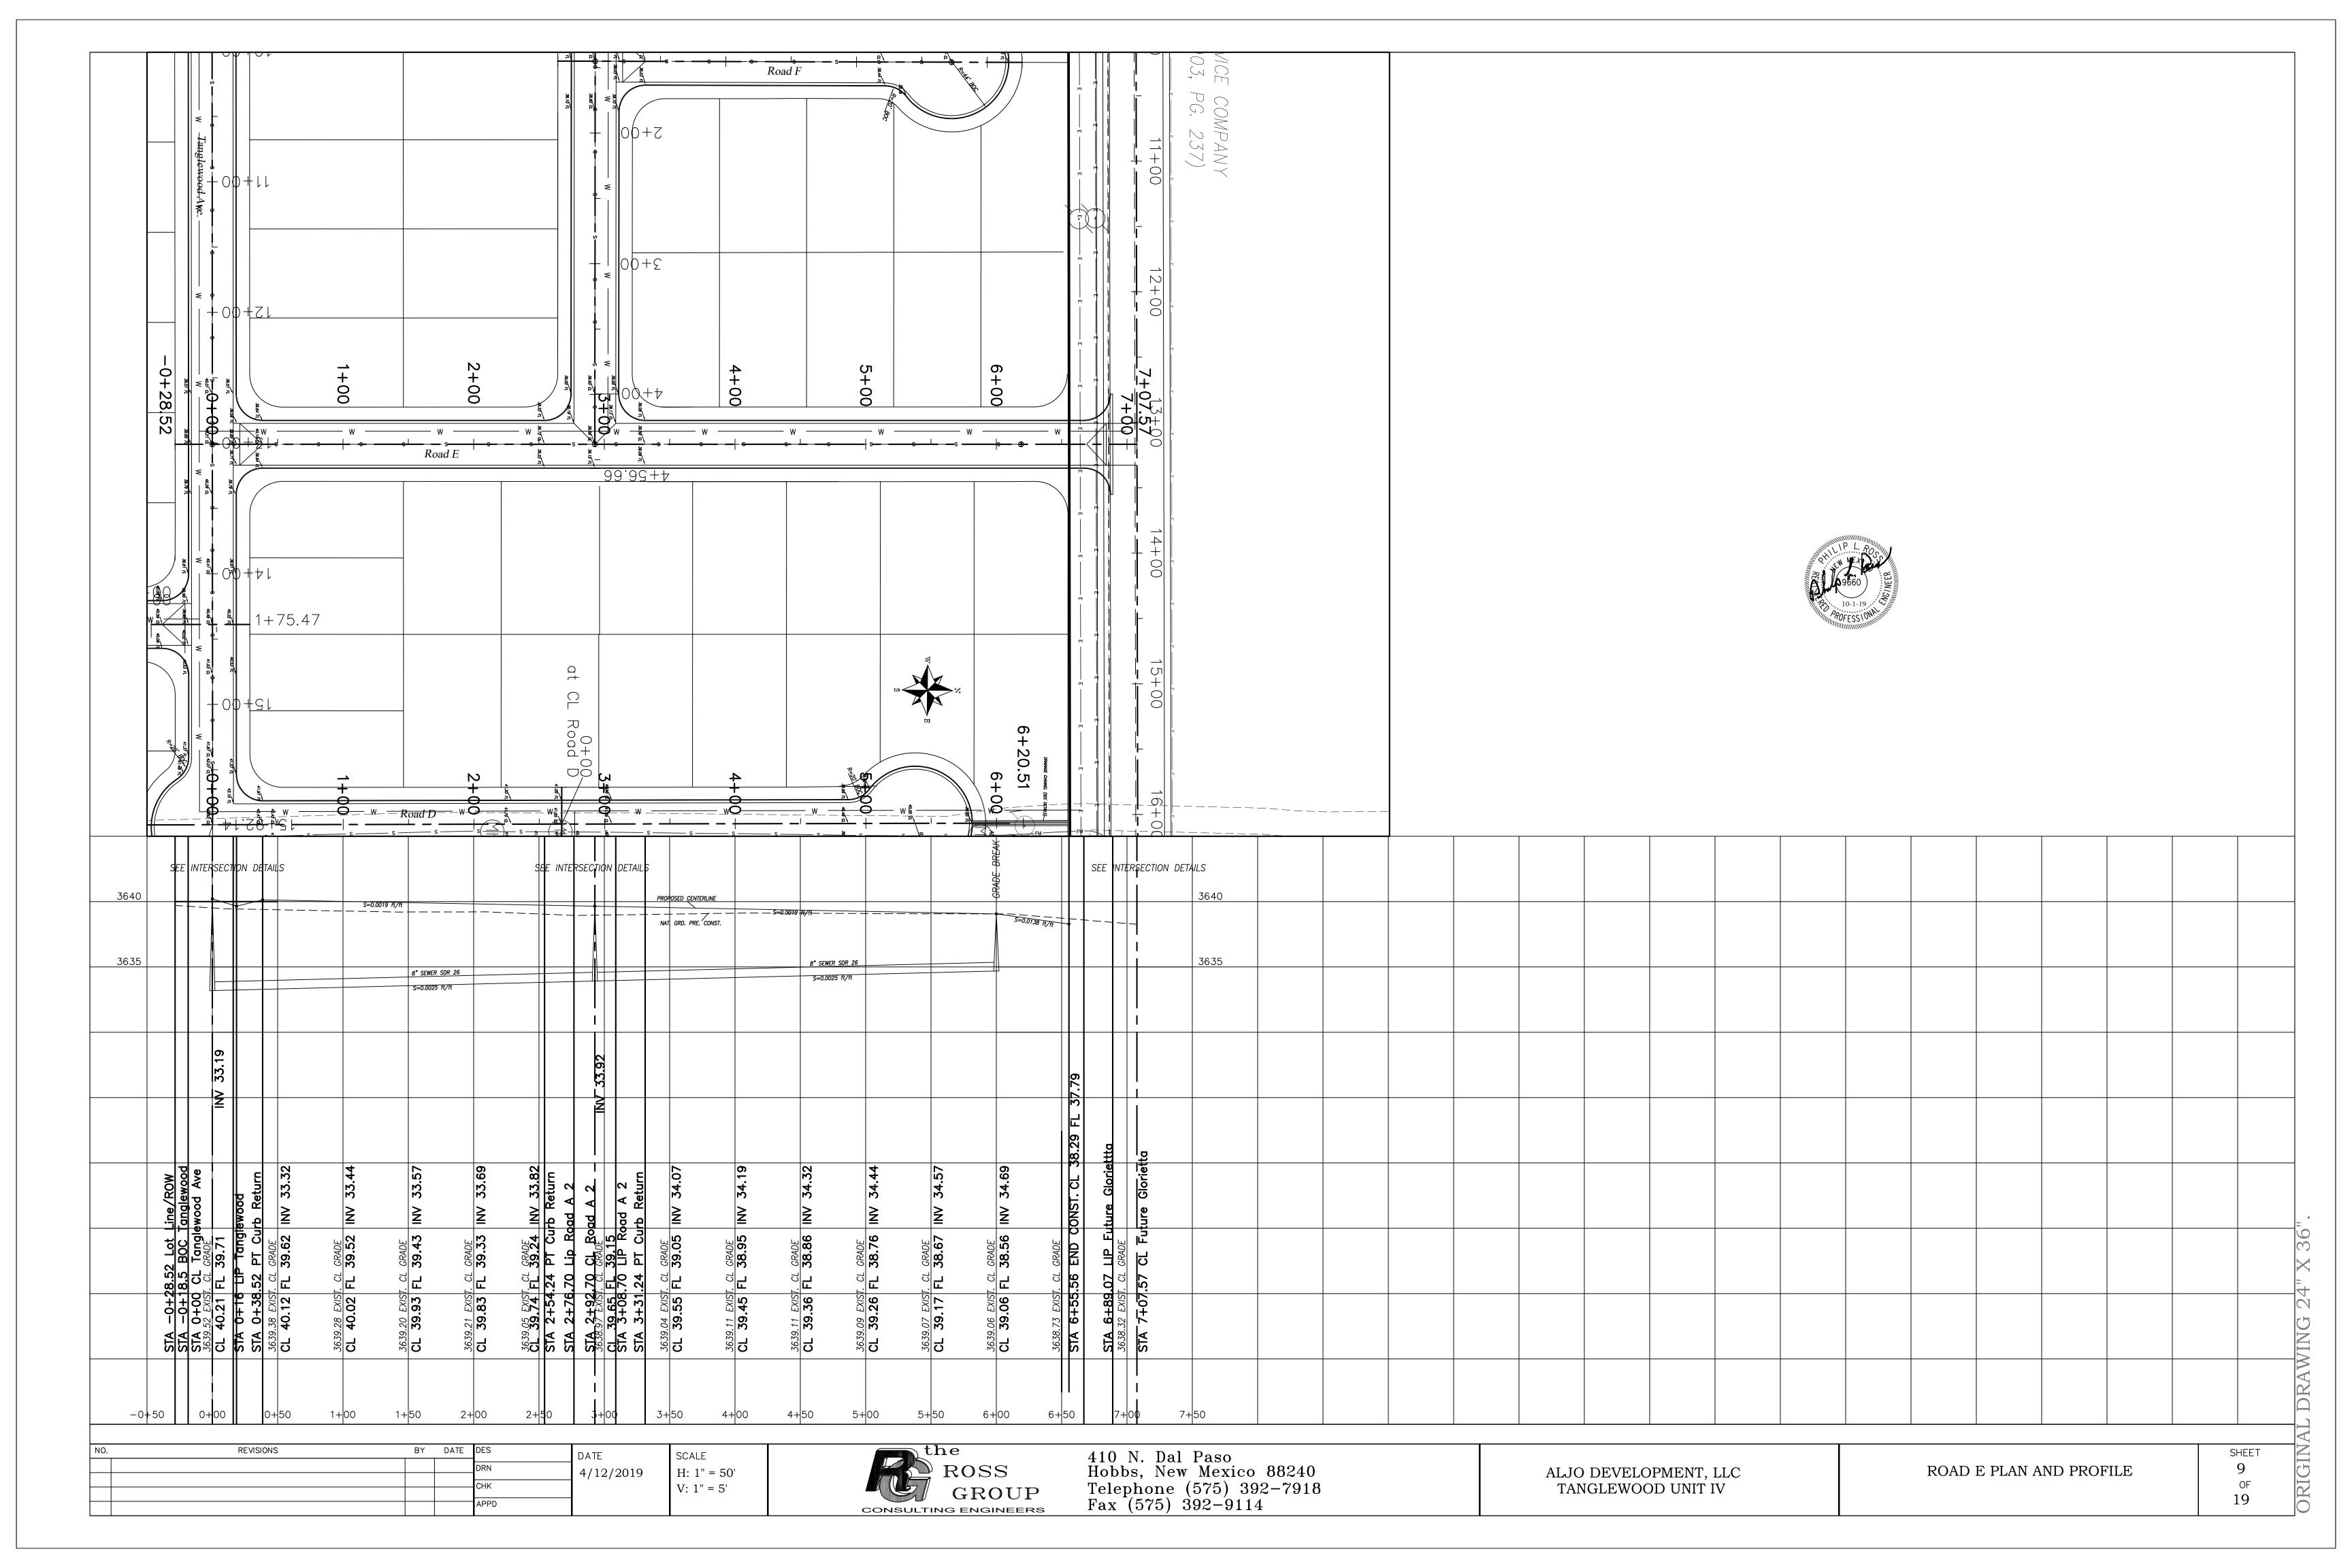


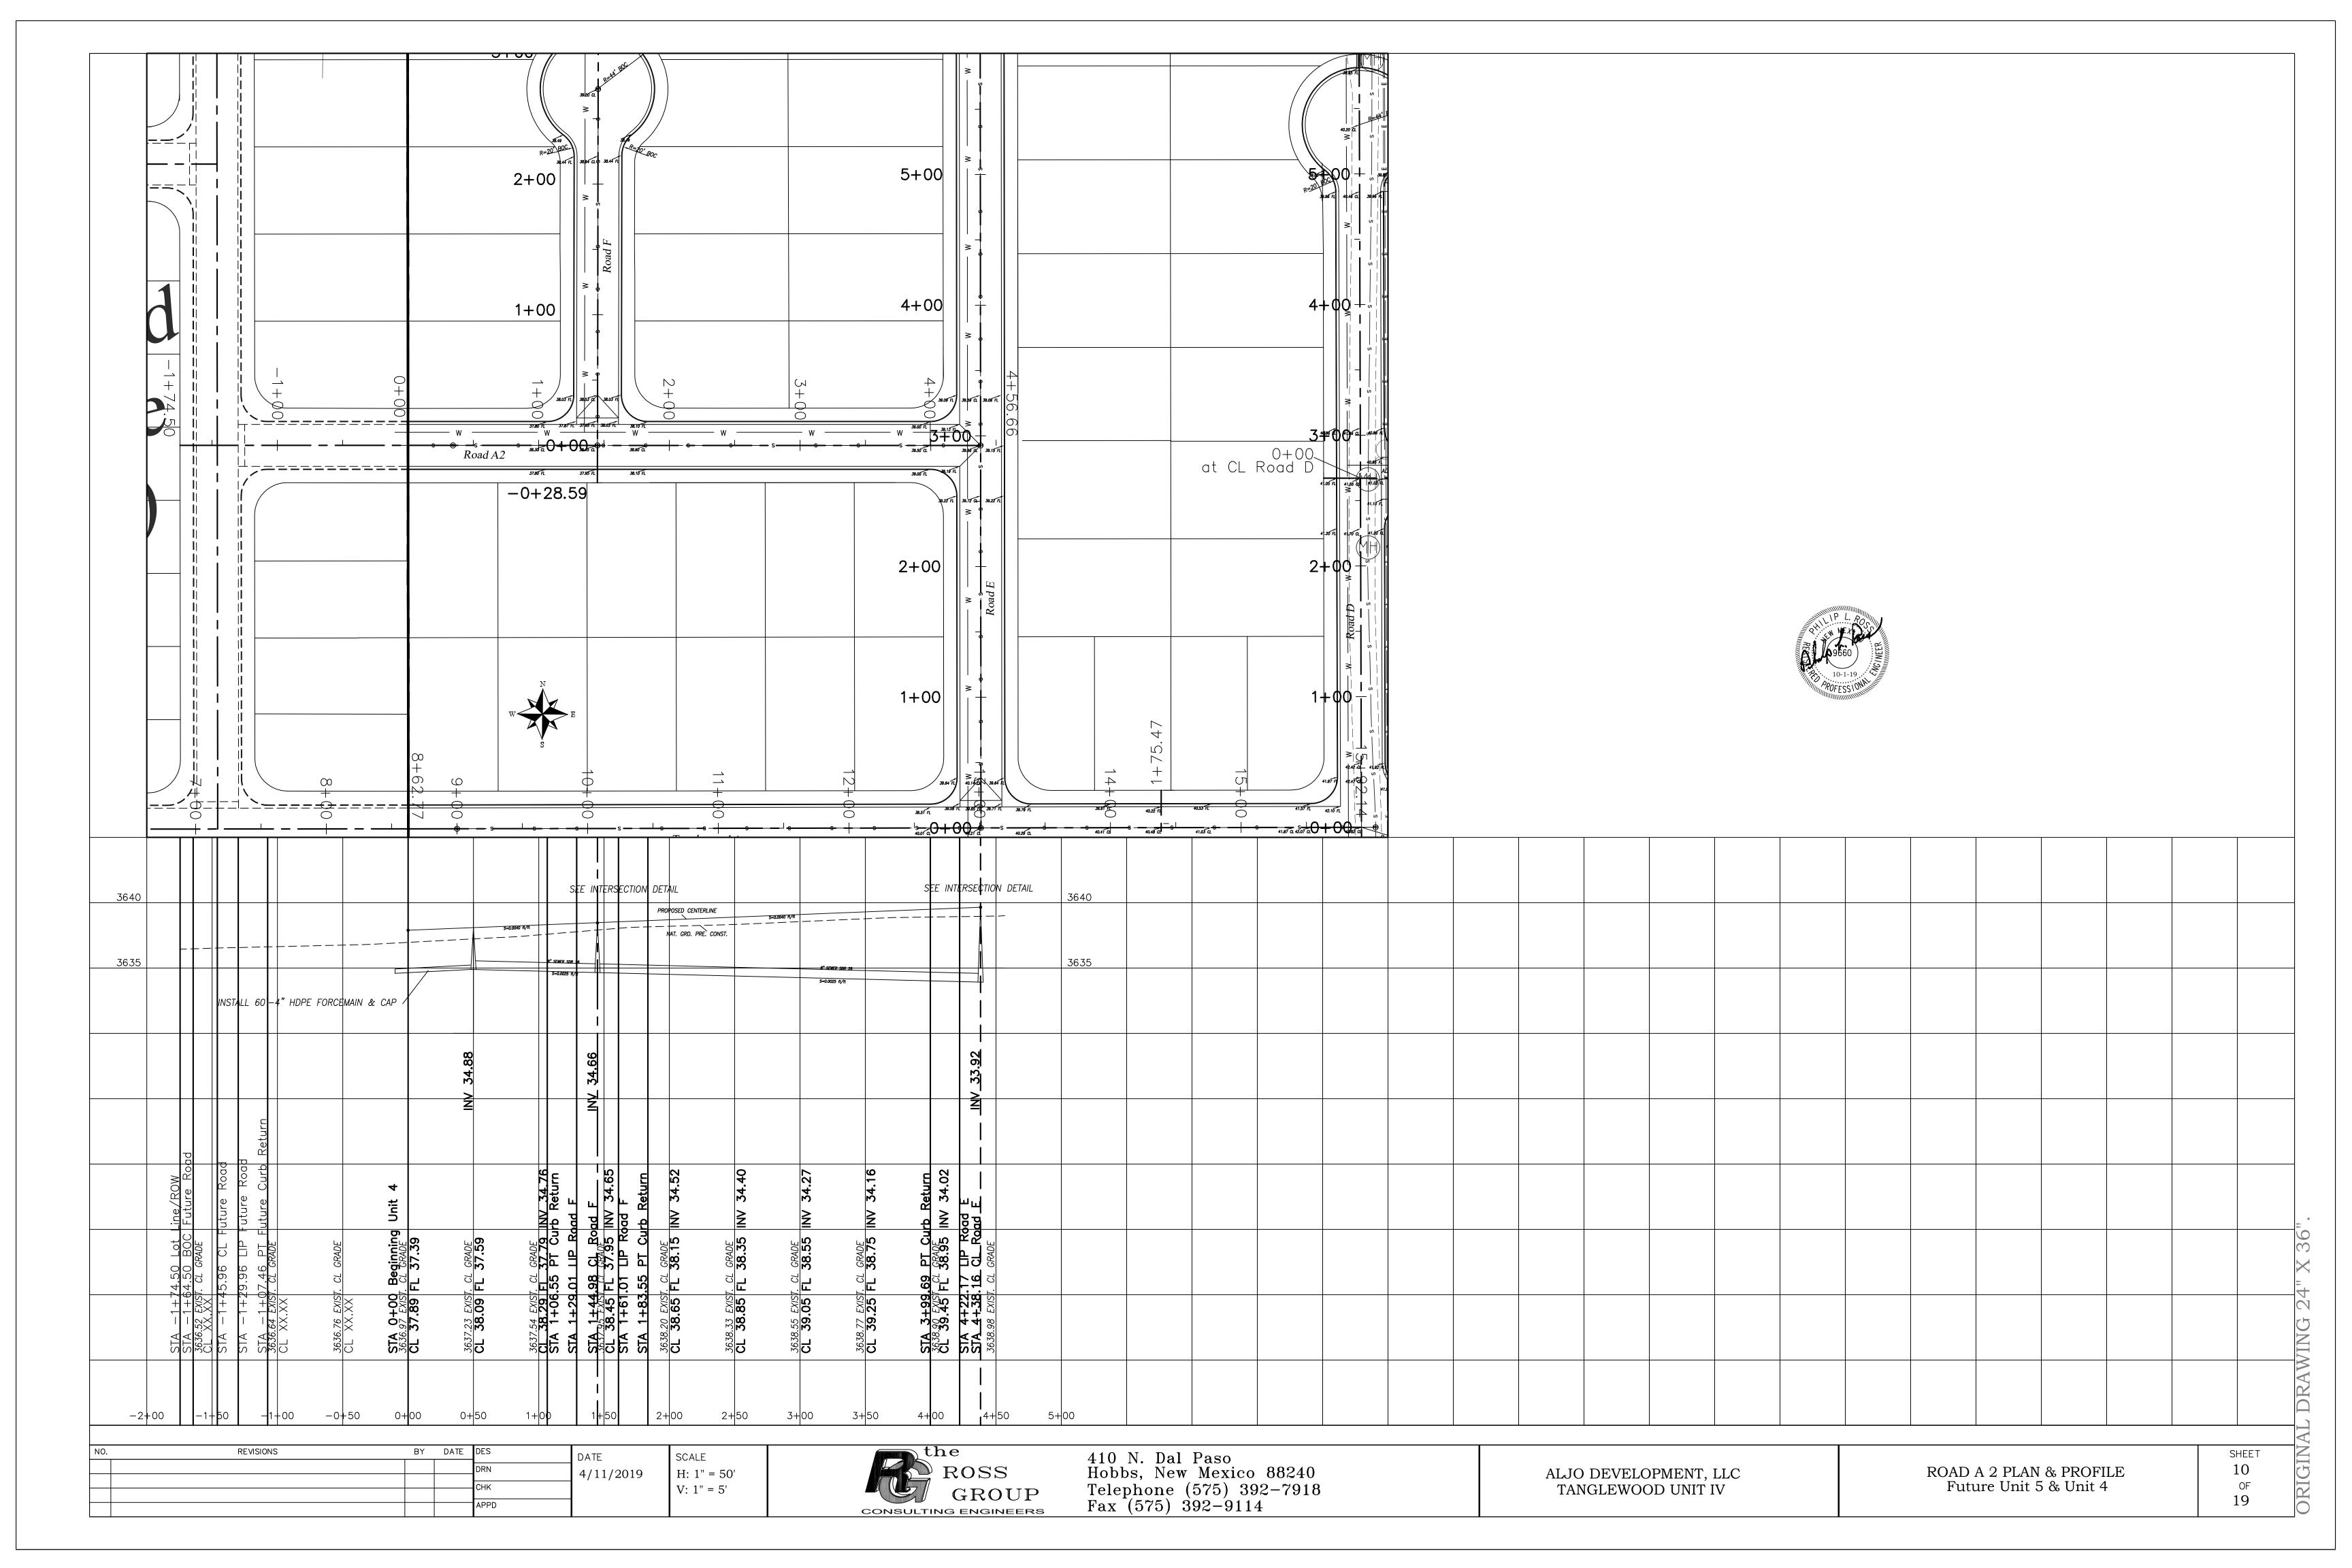


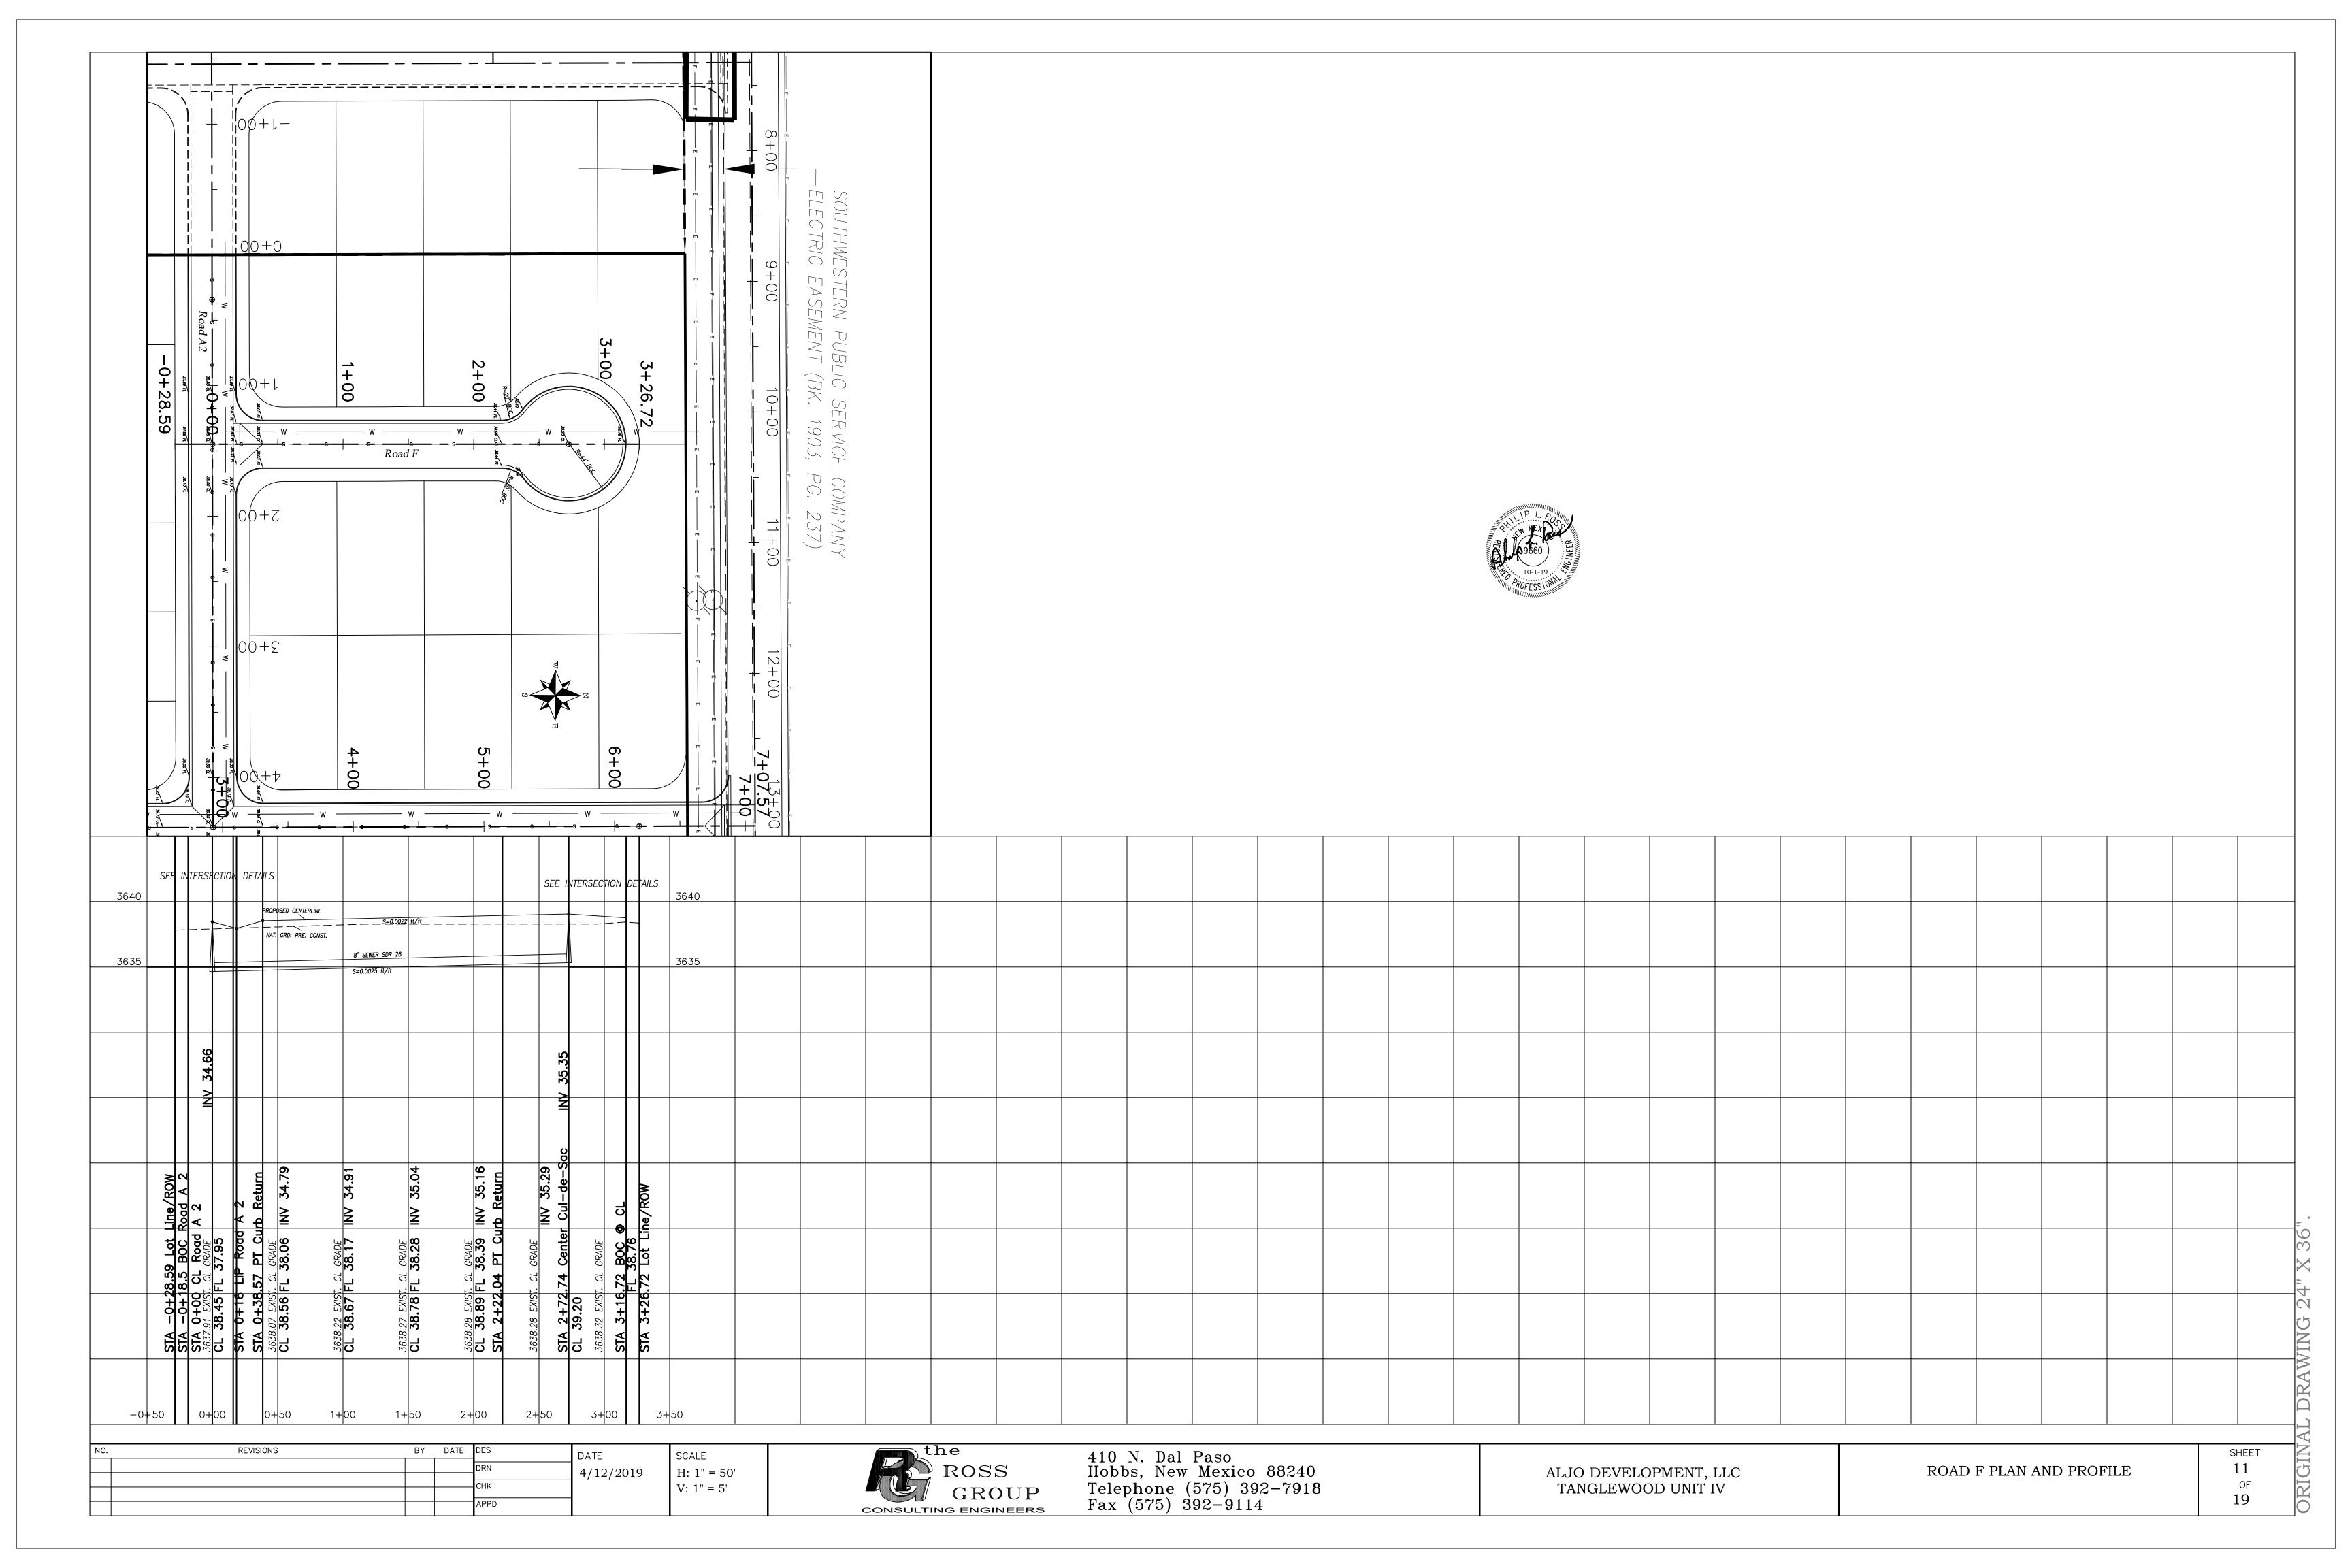

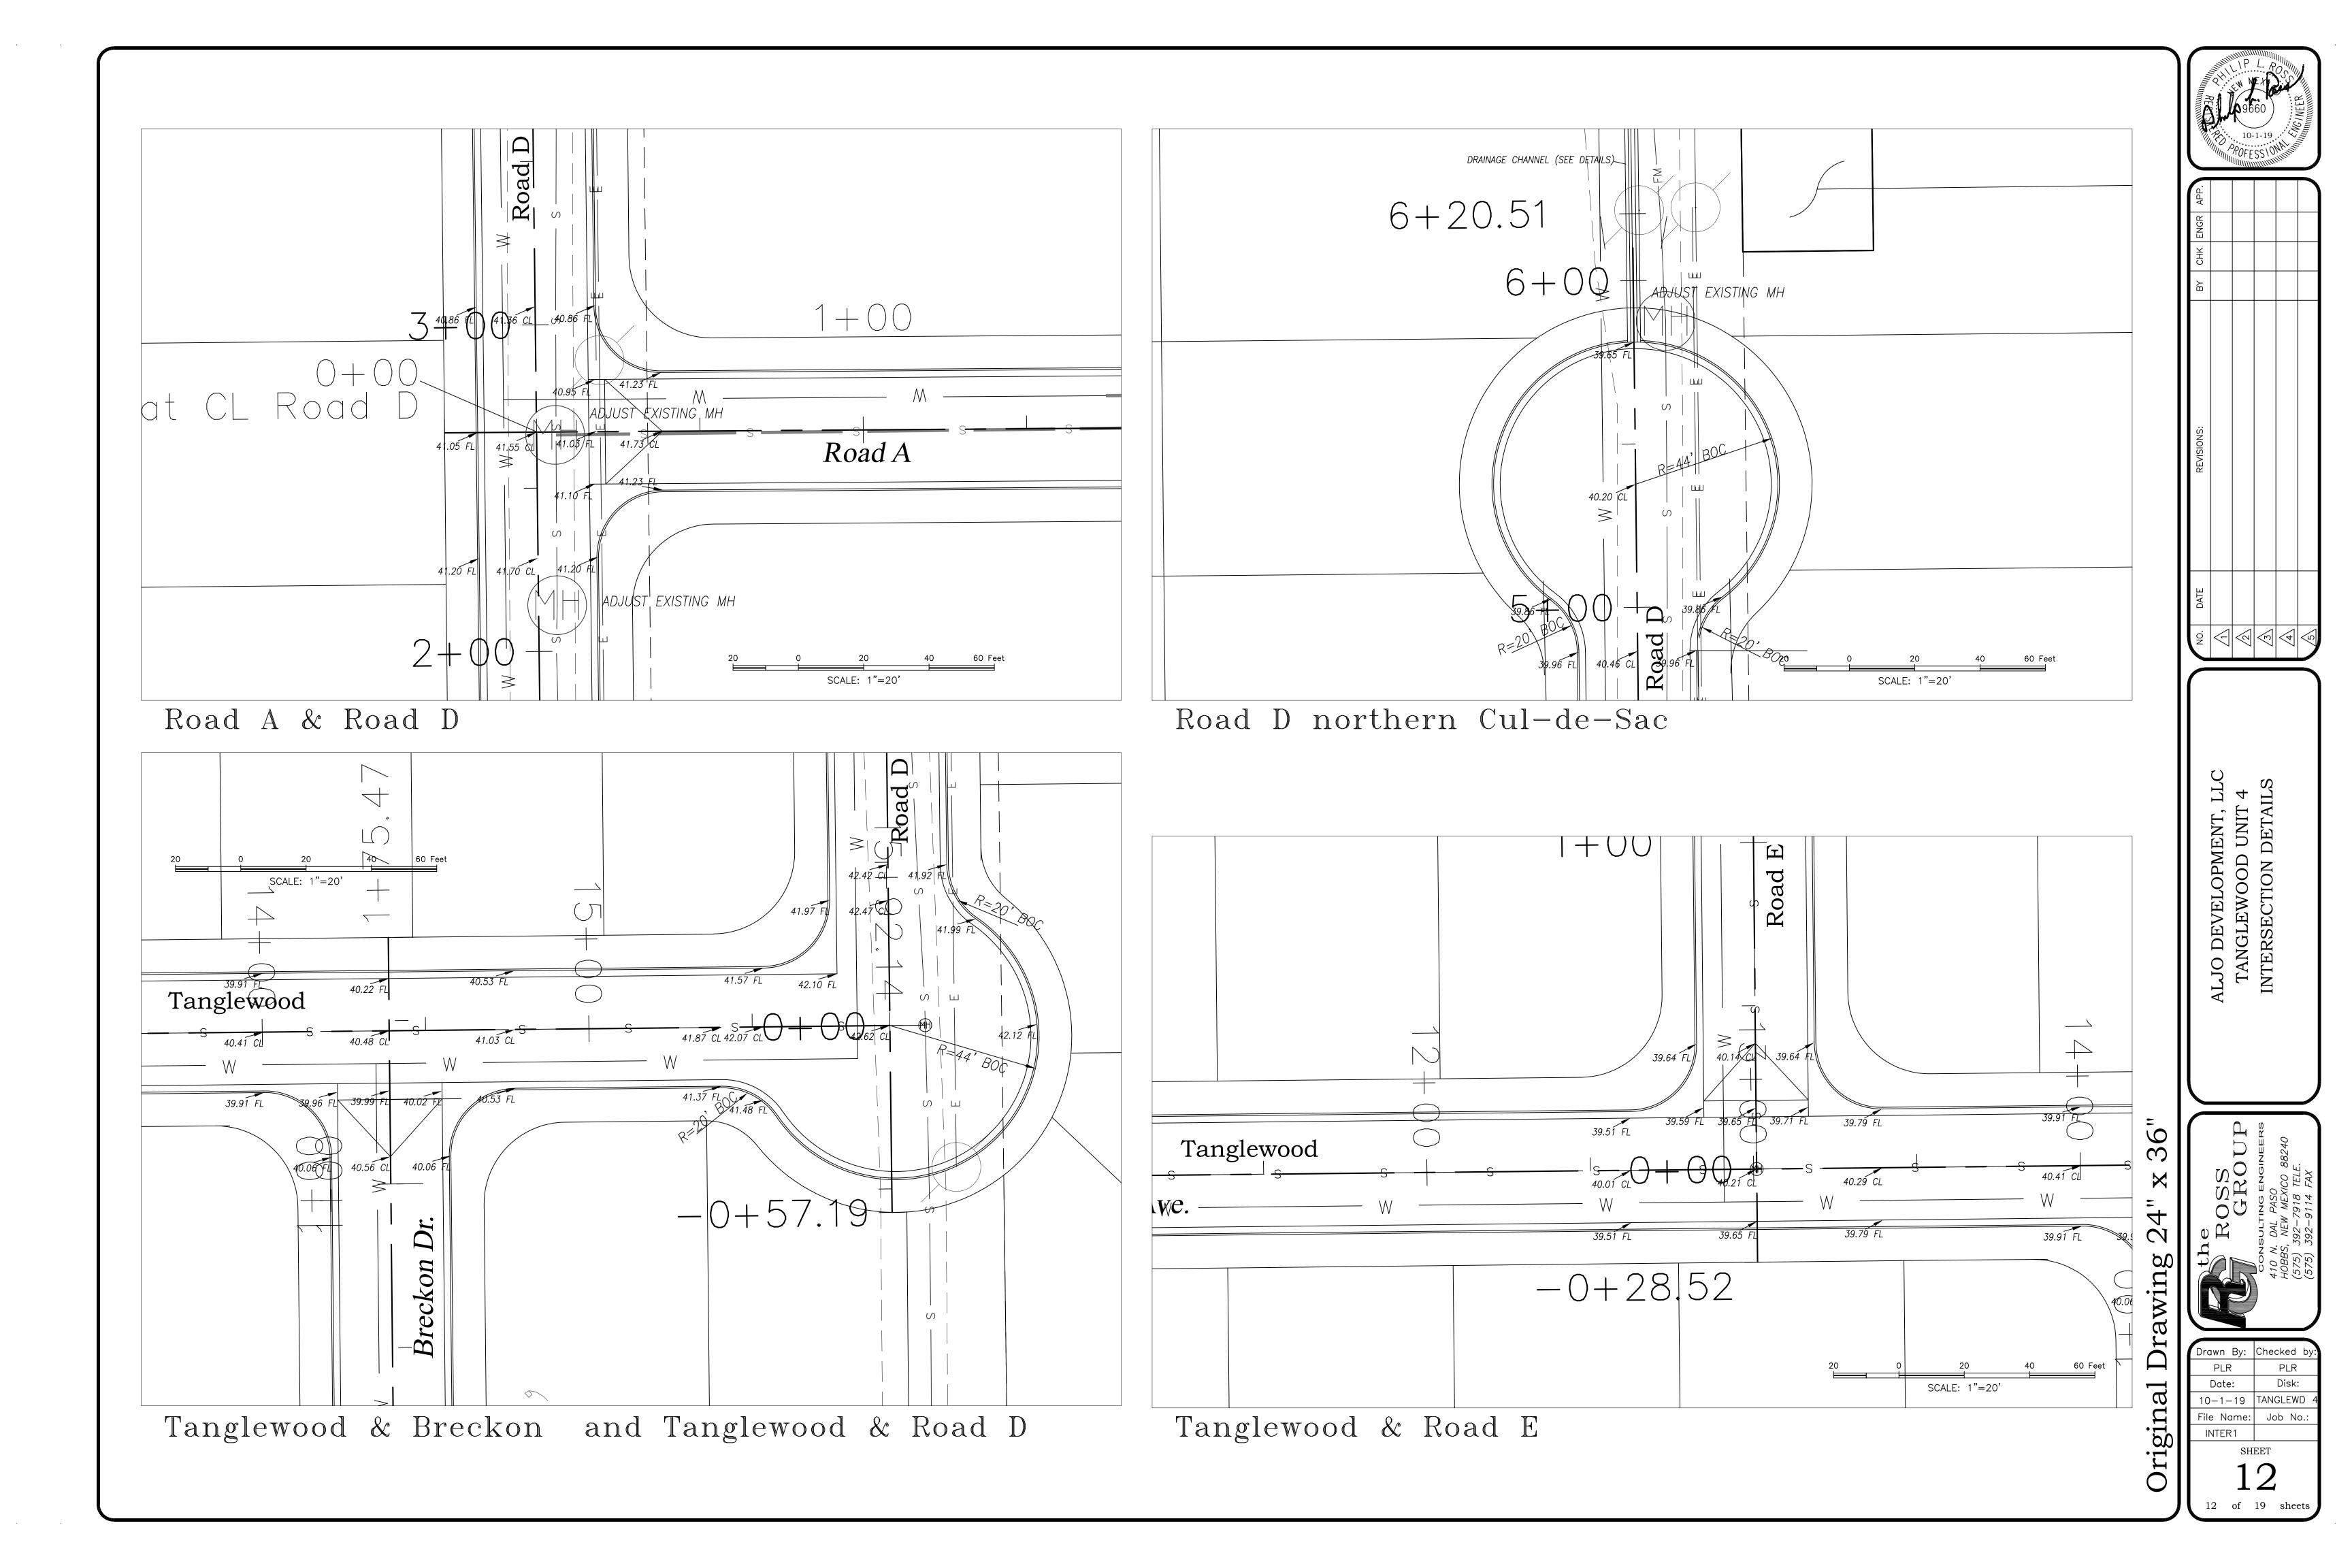

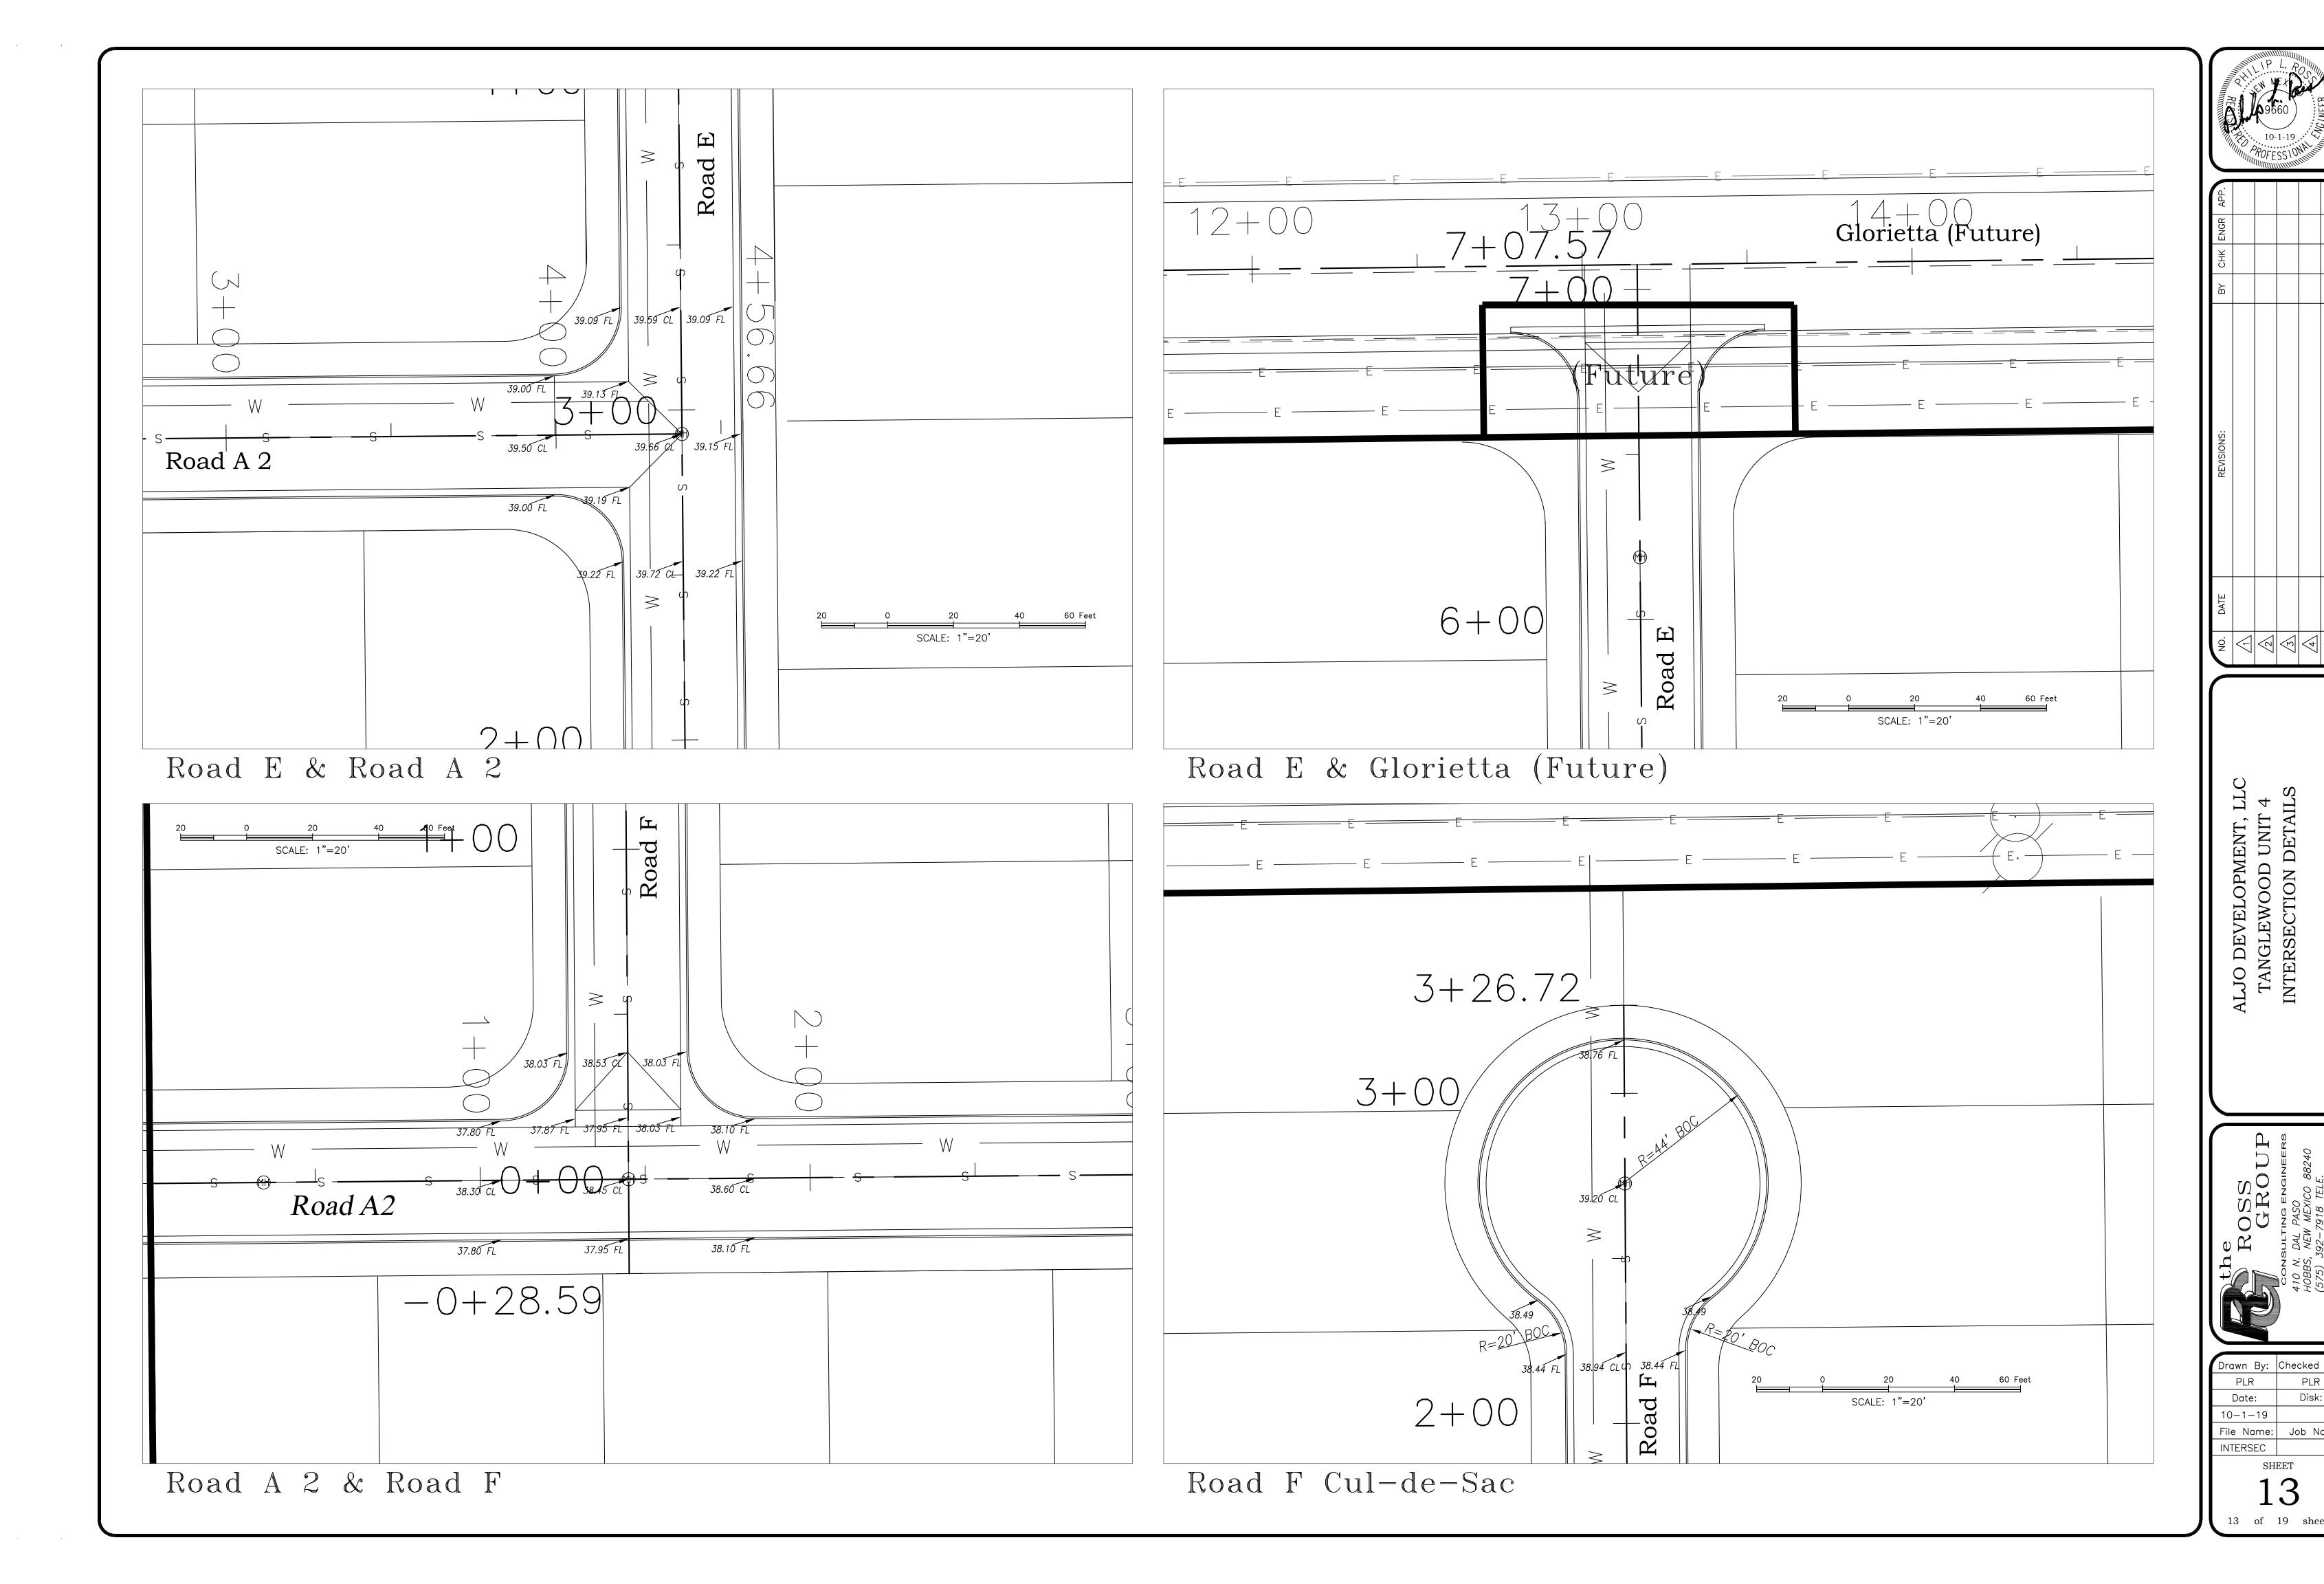

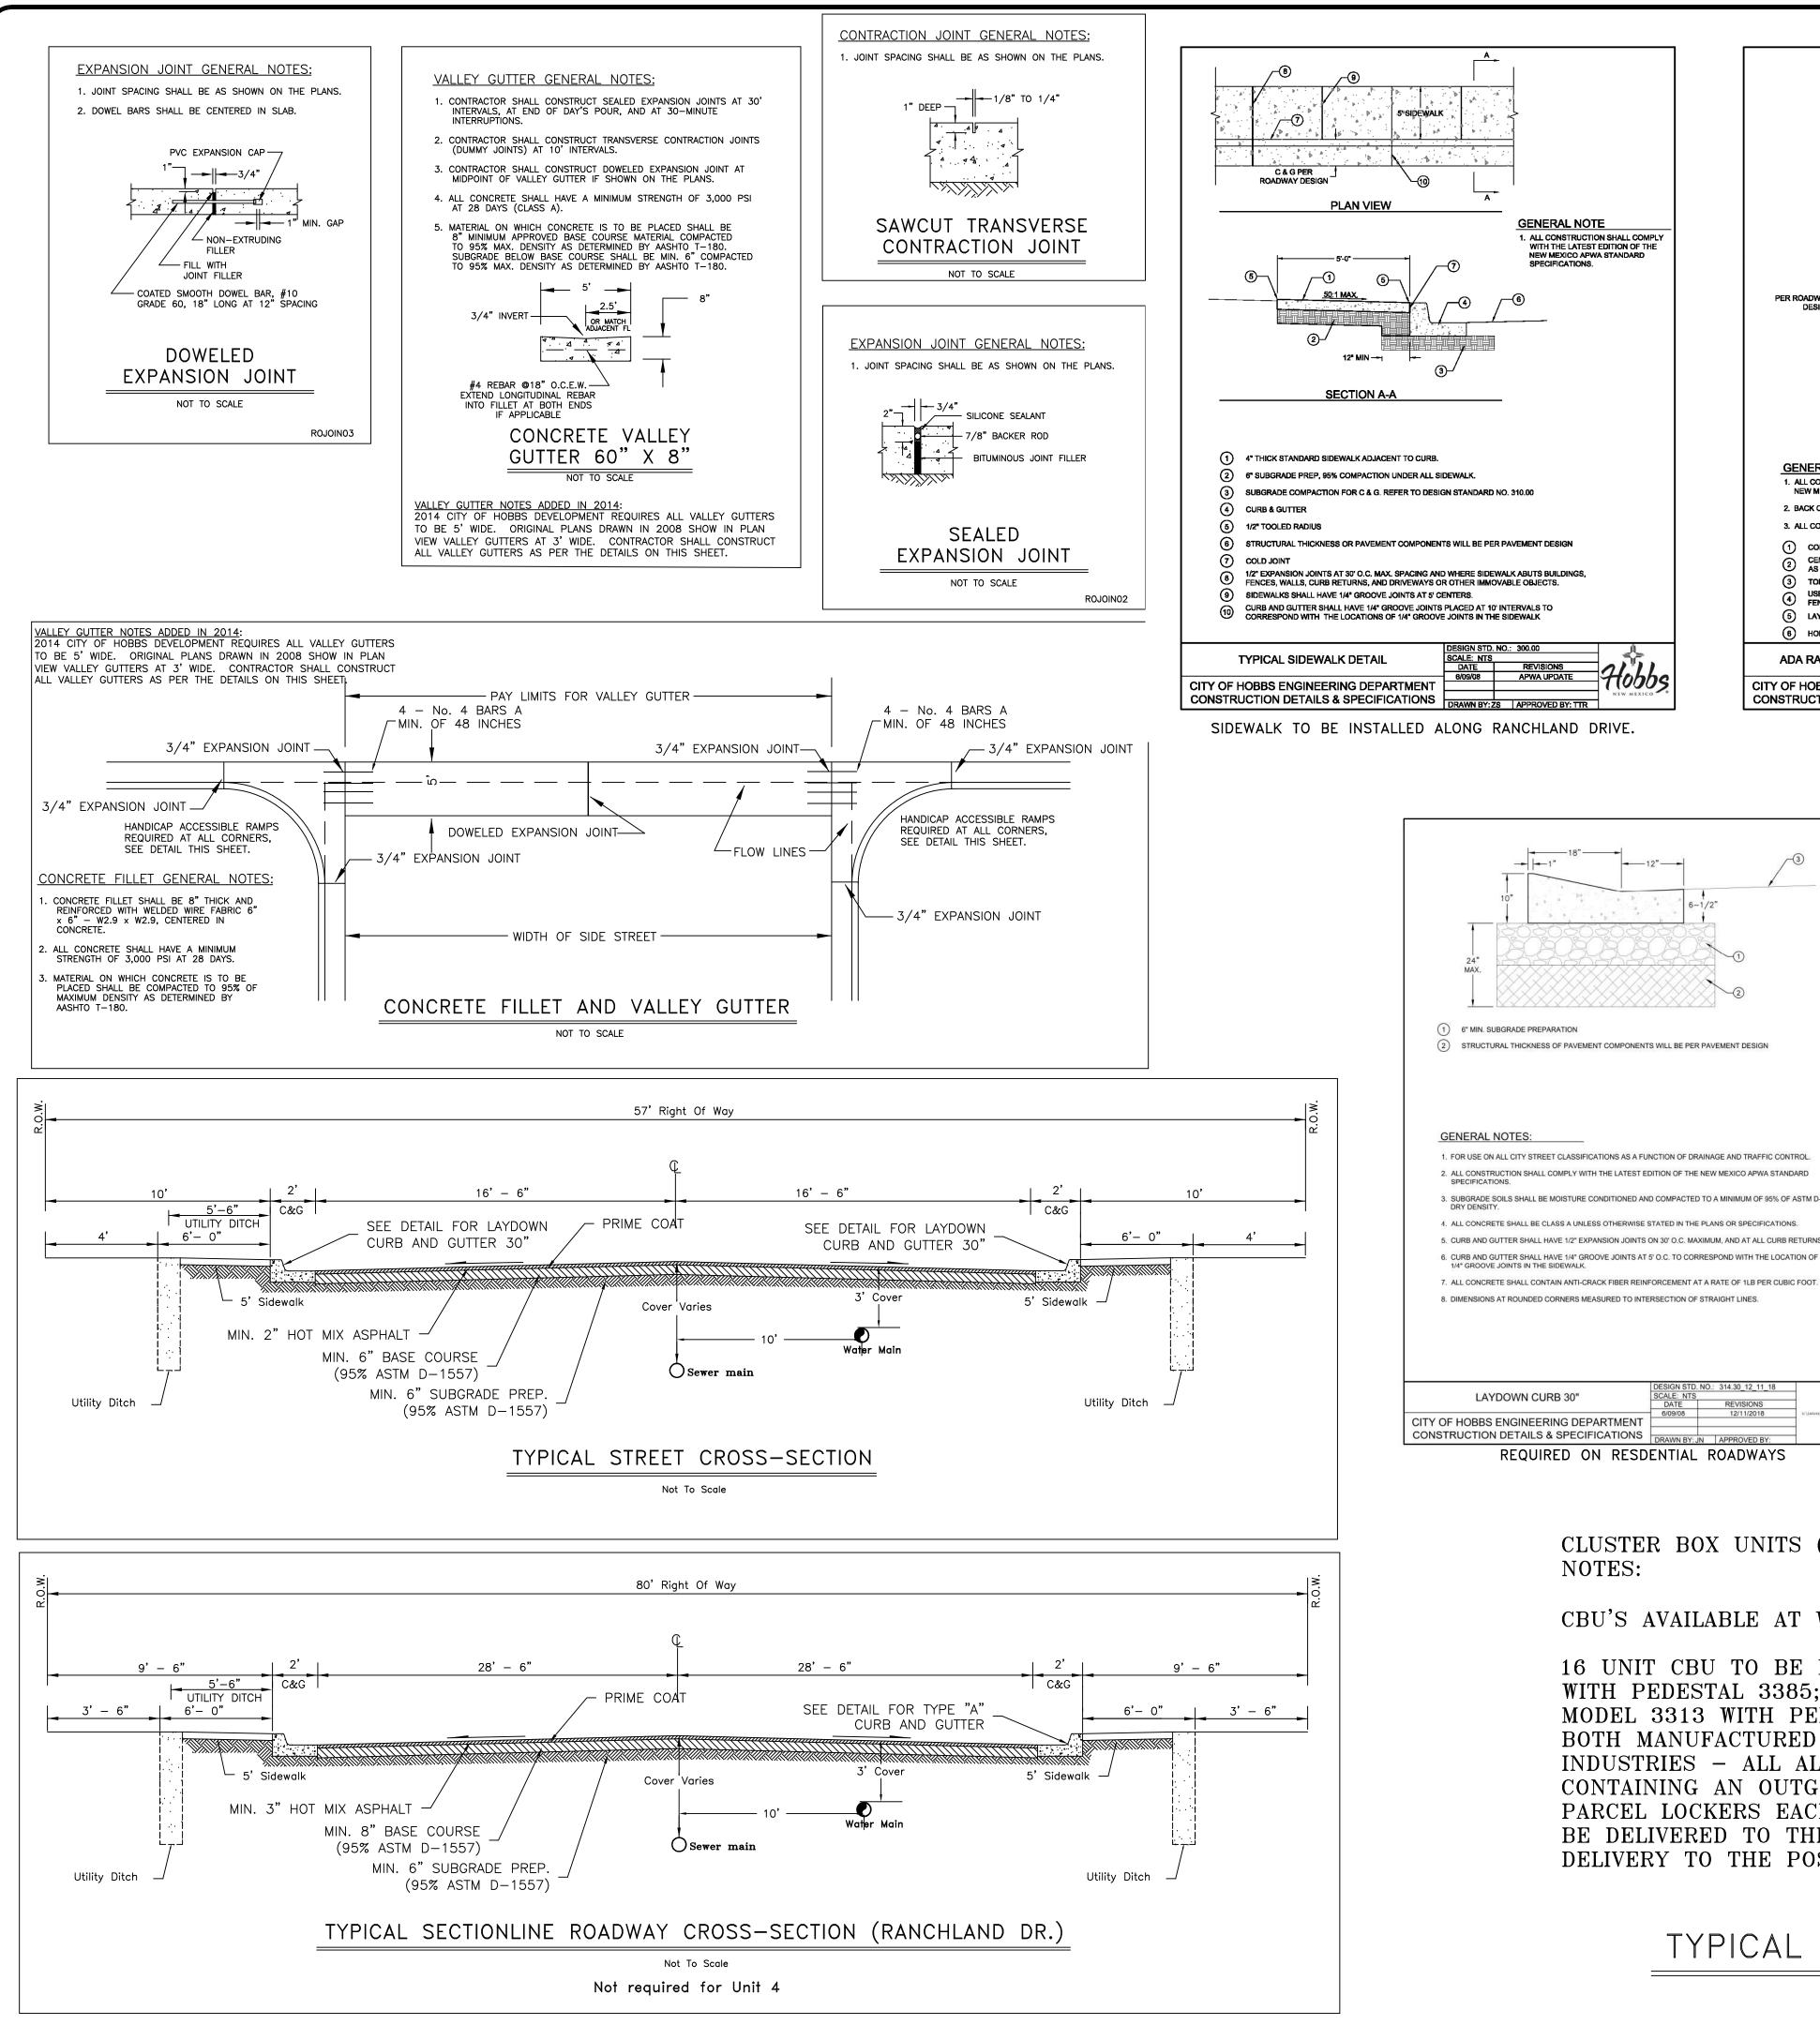

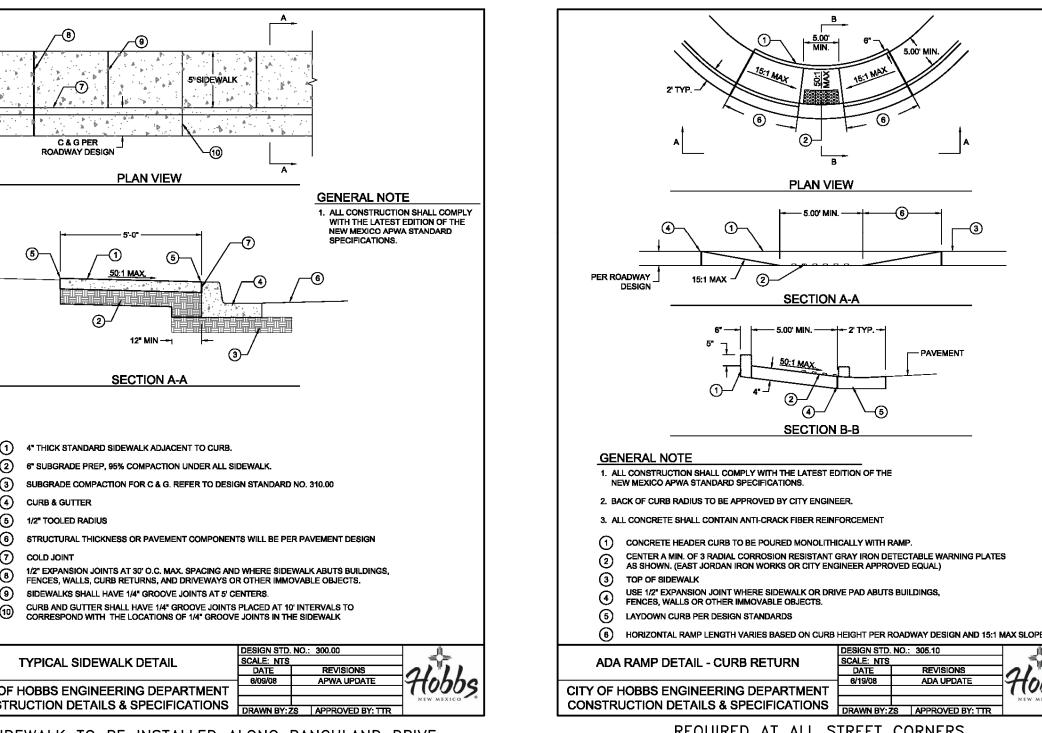

CLUSTER BOX UNITS (CBU'S) GENERAL

MODEL 3313 WITH PEDESTAL 3385.

DELIVERY TO THE POST OFFICE

BOTH MANUFACTURED BY SALSBURY

CBU'S AVAILABLE AT WWW.MAILBOXES.COM.

16 UNIT CBU TO BE MODEL NUMBER 3316,


WITH PEDESTAL 3385; 13 UNIT CBU TO BE


INDUSTRIES - ALL ALUMINUM CONSTRUCTION

CONTAINING AN OUTGOING MAIL SLOT AND 2

PARCEL LOCKERS EACH. ALL CBU KEYS TO

BE DELIVERED TO THE ENGINEER FOR

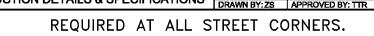

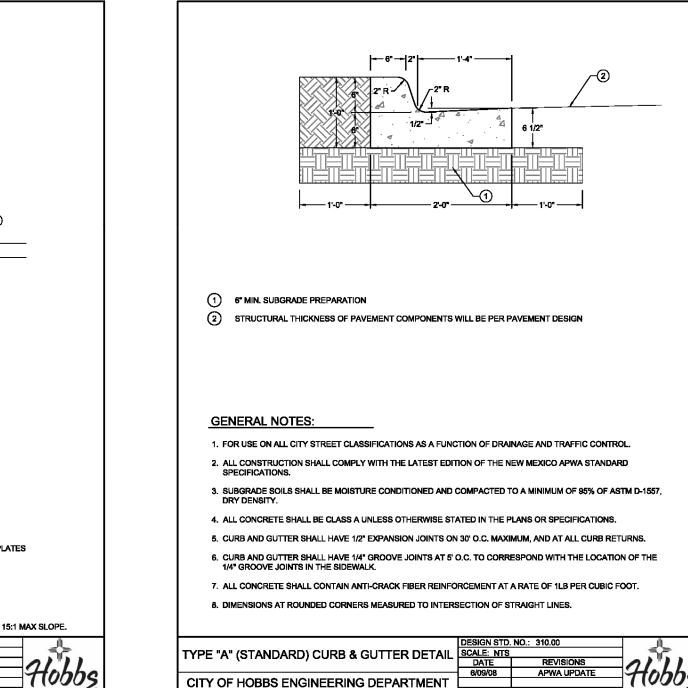

REQUIRED ON SECTION LINE ROADWAY (RANCHLAND) Not required for Unit 4

CONSTRUCTION DETAILS & SPECIFICATIONS


2 EA CORROSION RESISTANT GRAY IRON DETECTABLE WARNING PLATES AS SHOWN (EAST JORDAN IRON WORKS OR APPROVED EQUAL) PLAN VIEW

\* DETECTABLE WARNING PLATES REQUIRED FOR DRIVE PADS 30 FEET IN LENGTH OR GREATER - GUTTER FLOW LINE ----<u>-50 : 1</u>---4. ALL SUBGRADE SHALL BE COMPACTED TO 95% PER ASTM D-1557 5. USE STEEL CHAIRS TO SUPPORT THE REBAR IN CURB AT DRIVE PAD 6. ALL CONCRETE SHALL BE CLASS A AND CONTAIN ANTI- CRACK HD (AR GLASS FIBER) . DRIVEPAD CURB AND 6" PORTION OF 3' TRANSITION SHALL BE PAID FOR UNDER DRIVEPAD 9. 1/4" GROOVE JOINTS SHALL BE PLACED AT 5' O.C. TYPE CITY OF HOBBS ENGINEERING DEPARTMENT CONSTRUCTION DETAILS & SPECIFICATIONS

ALL CONCRETE WORK SHALL INCLUDE FIBER REINFORCEMENT. FIBERS SHALL BE VIRGIN POLYPROPYLENE STRANDS (APPROX. 3/4 inches IN LENGTH). ALL CONCRETE SHALL CONTAIN APPROXIMATELY 1.5 LBS. OF FIBER PER CUBIC YARD OF CONCRETE. OR PAYMENT WILL BE MADE FOR SUCH WORK AND SHALL BE CONSIDERED INCIDENTAL TO CONSTRUCTION. FIBER REINFORCEMENT DOES DELETE REQUIREMENT FOR STEEL REINFORCEMENT WHEN REQUIRED BY DETAILS ON THIS SHEET.

ROADWAY CONSTRUCTION

GENERAL NOTES:

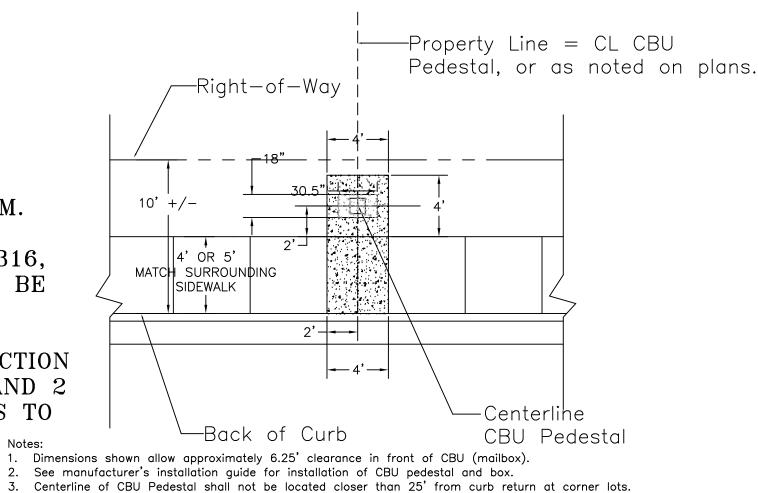



TYPICAL CLUSTER BOX UNIT (CBU) CONCRETE DETAIL

4. If CBU placed in area with out curb and gutter, 4' x 4' sidewalk still required in front of slab for pedestal.

Drawn By: Checked b SMM Date: 6/20/19 | GENERAL File Name: | Job No. ROAD

UNI

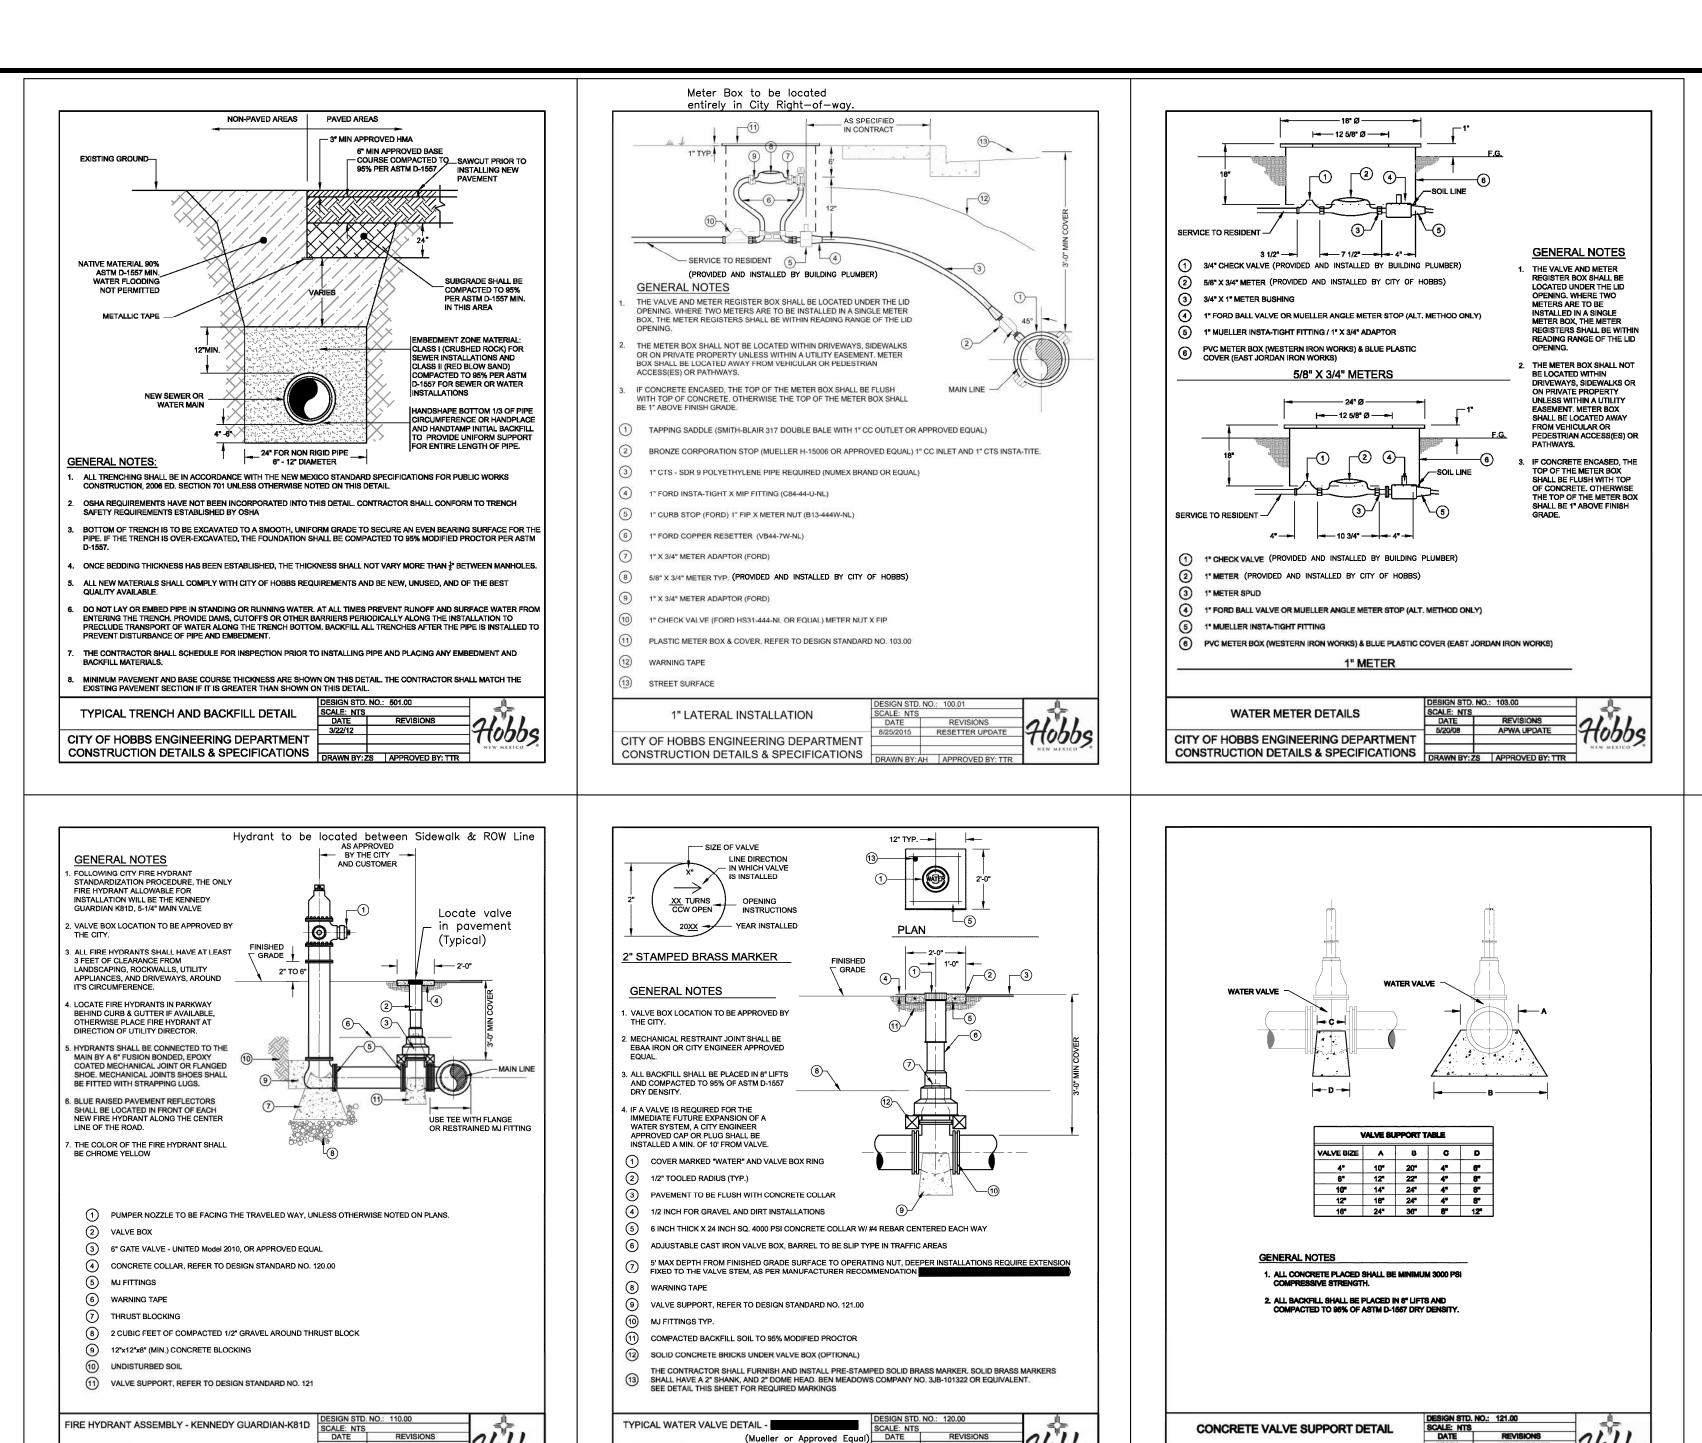


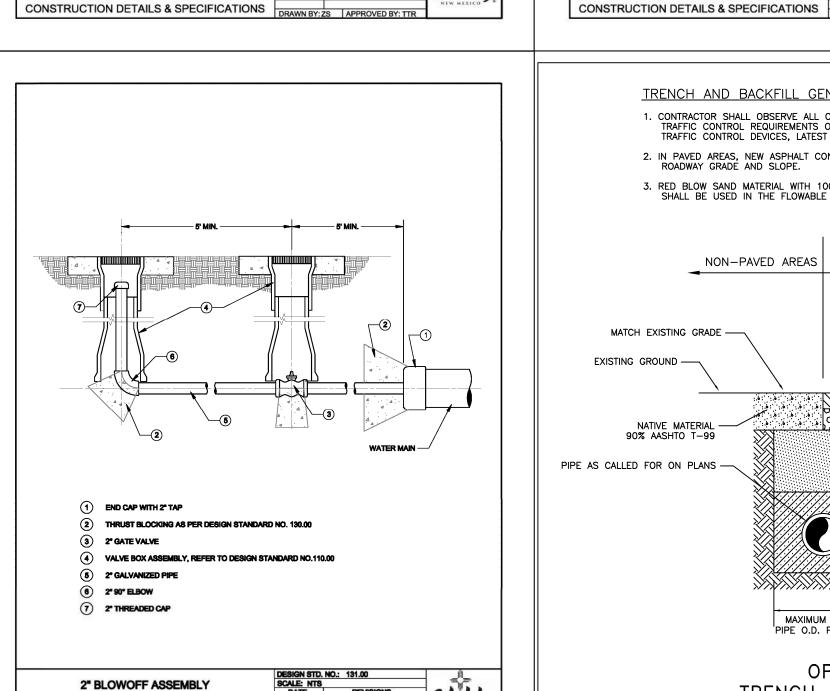

CITY OF HOBBS ENGINEERING DEPARTMENT

CITY OF HOBBS ENGINEERING DEPARTMENT

CONSTRUCTION DETAILS & SPECIFICATIONS DRAWN BY: ZS APPROVED BY: T

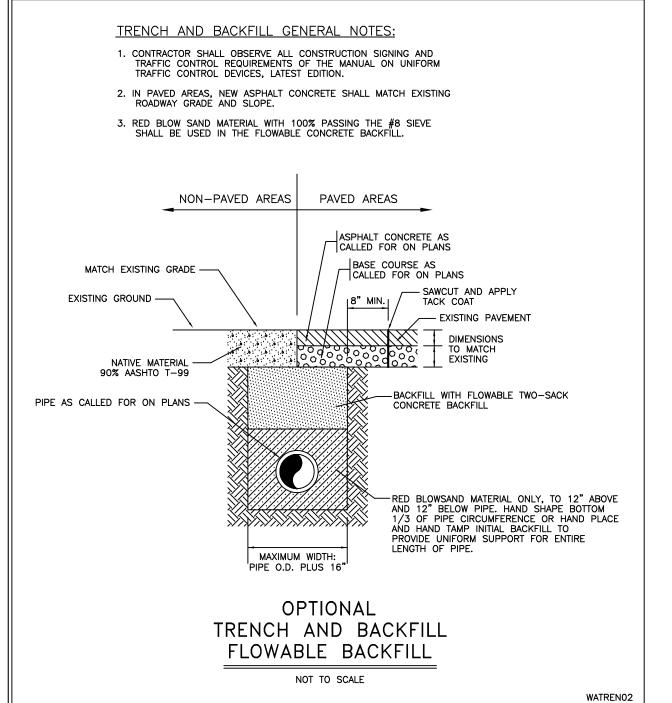


CITY OF HOBBS ENGINEERING DEPARTMENT

CITY OF HOBBS ENGINEERING DEPARTMENT

CONSTRUCTION DETAILS & SPECIFICATIONS

90°-45° 22 1/2°-11 1/4° 2 ELEVATION (TEE) 8" 22 1/2"-11 1/4" 2 12" | 22 1/2"-11 1/4" | 2" ELEVATION (PLUG) 45° 3'-6" 3'-6" 14" | 22 1/2"-11 1/4" | 3' CONSTRUCTION NOTES GENERAL NOTES 1. ALL CONCRETE PLACED SHALL BE MINIMUM 3000 PSI 2. ALL BACKFILL SHALL BE PLACED IN 8" LIFTS AND COMPACTED TO 95% OF ASTM D-1557 DRY DENSIT ELEVATION (ELBOW) TRENCH WALLS (2) UNDISTURBED EARTH CONCRETE BLOCKING DETAILS CITY OF HOBBS ENGINEERING DEPARTMENT CONSTRUCTION DETAILS & SPECIFICATIONS

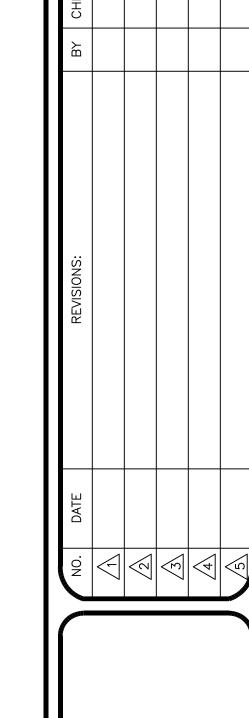

9

3

24

SIZE

MIN


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Drawn By: Checked b SMM PLR Date: Disk: GENERAL 6/20/19 File Name: Job No. WATER SHEET

of 19 sheets



1) USE D.I. OR P.V.C. (SDR 21) PIPE THROUGHOUT DROP.

BEFORE CONSTRUCTING DROP SUPPORT.

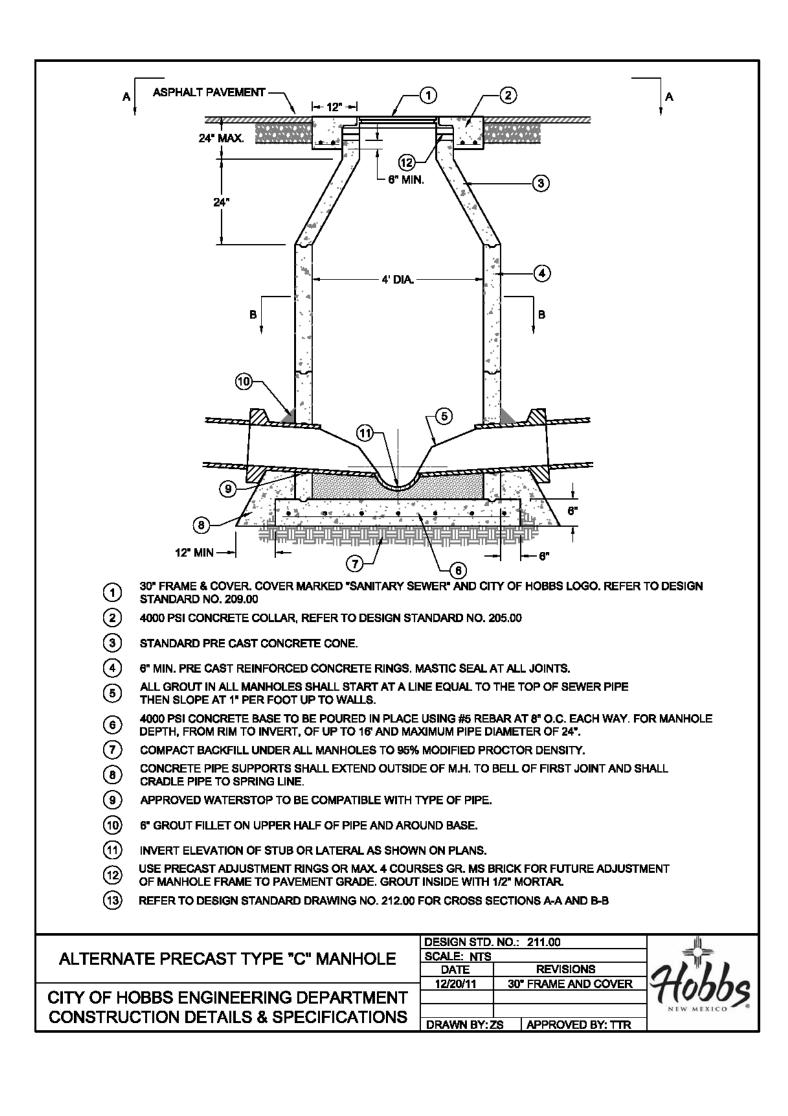THEN SLOPE AT 1" PER FOOT UP TO WALLS.

**VERTICAL DROP AT MANHOLE** 


CITY OF HOBBS ENGINEERING DEPARTMENT CONSTRUCTION DETAILS & SPECIFICATIONS


(2) USE BELL AND SPIGOT 45° SHORT OR LONG RADIUS BEND.


DEPTH OF UP TO 16' AND MAX. PIPE DIAMETER OF 30".


(8) INVERT ELEVATION OF STUB OR LATERAL AS SHOWN ON PLANS.

(10) CORE DRILL FOR ALL WALL PENETRATIONS ON EXISTING MANHOLES.

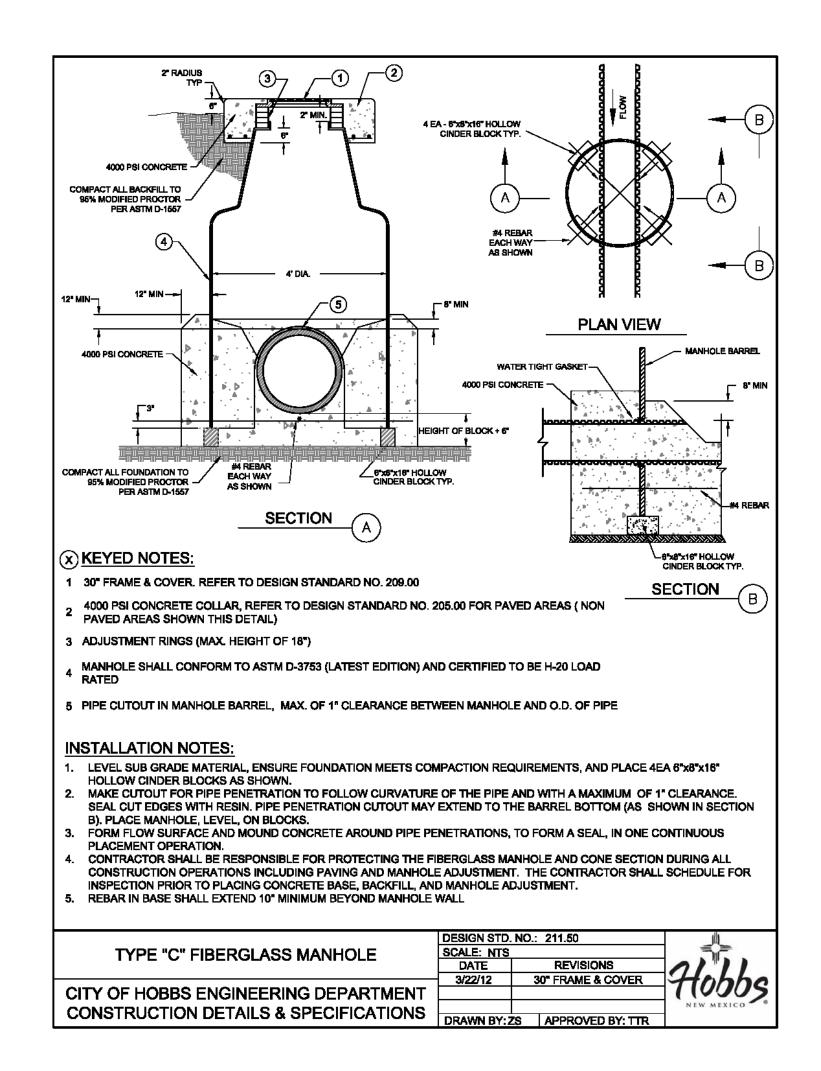


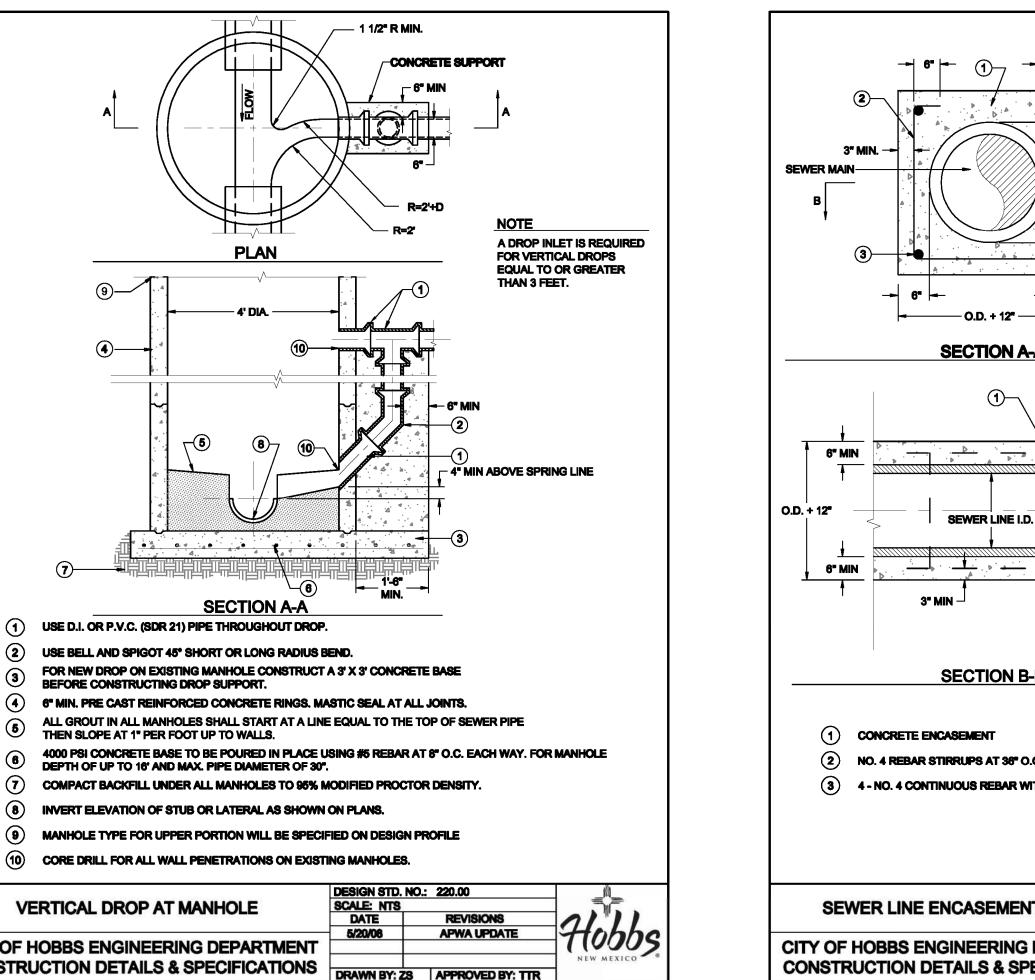

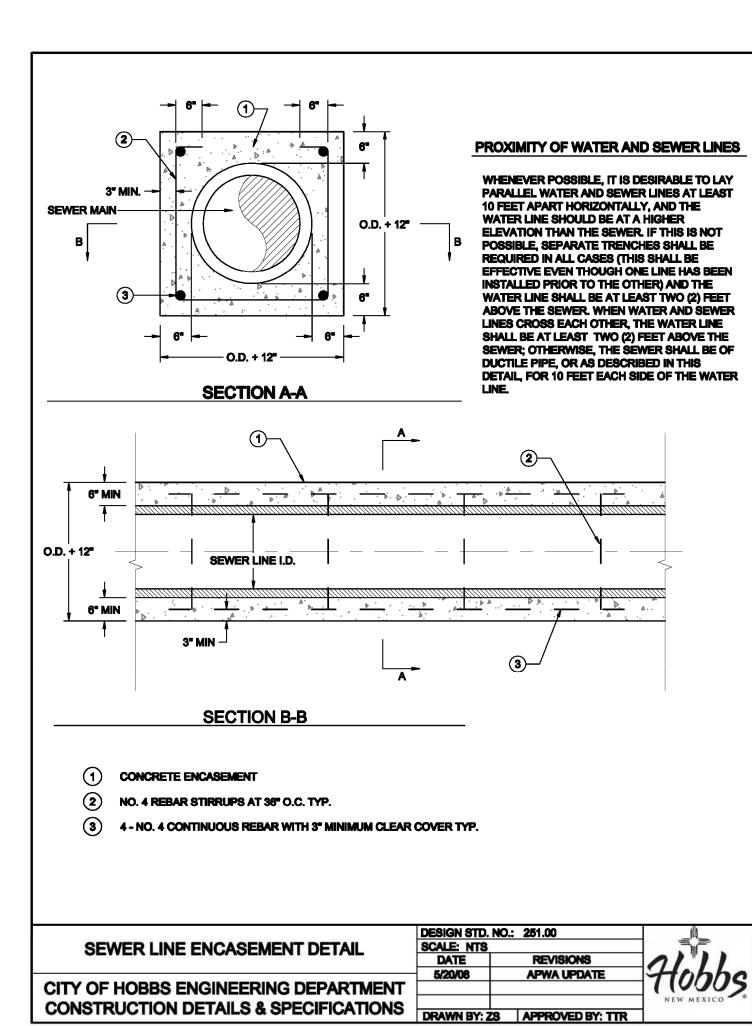

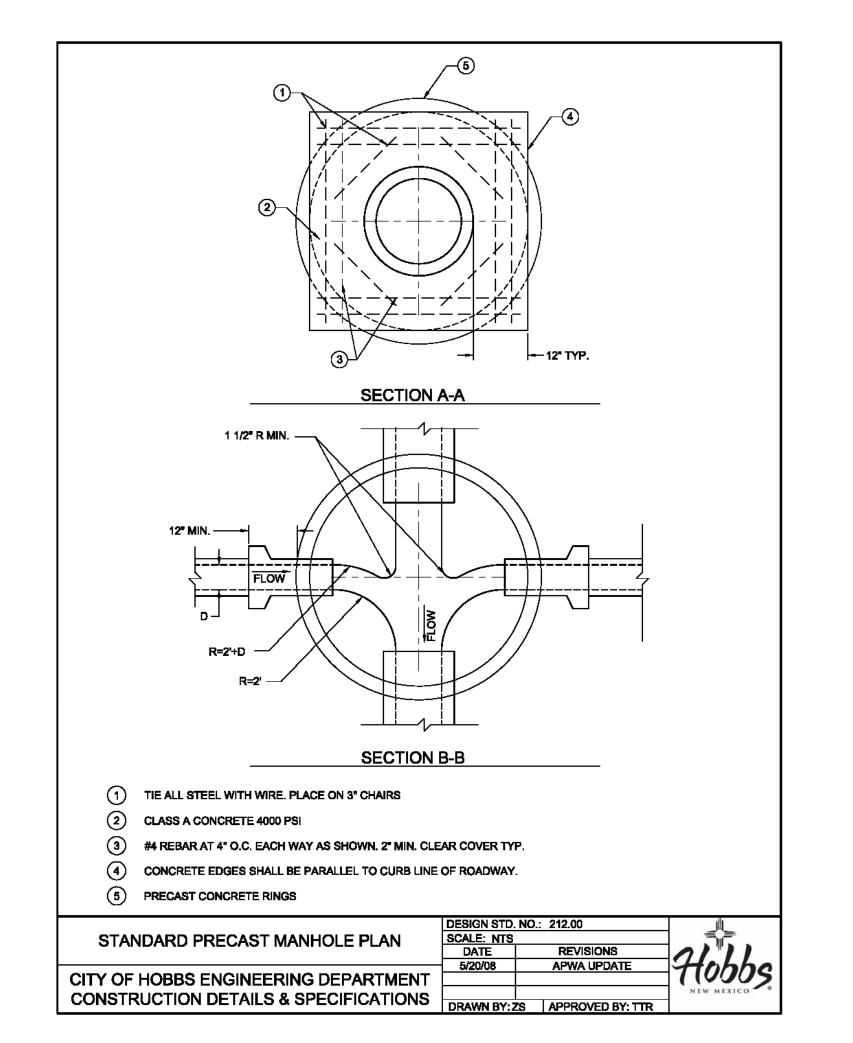


SEE SHEET 15 (WATER DETAILS) FOR TYPICAL TRENCH DETAILS, MECHANICAL COMPACTION AND OPTIONAL FLOWABLE FILL.

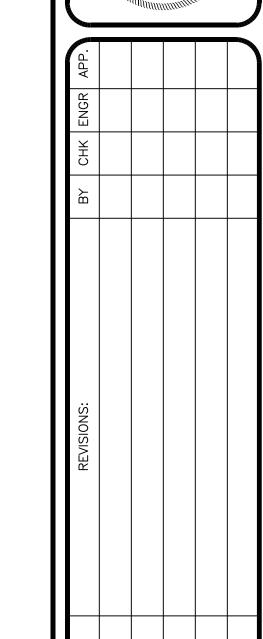

SMM

Drawn By: Checked b Date: 6/20/19 GENERAL File Name: Job No. SEWER

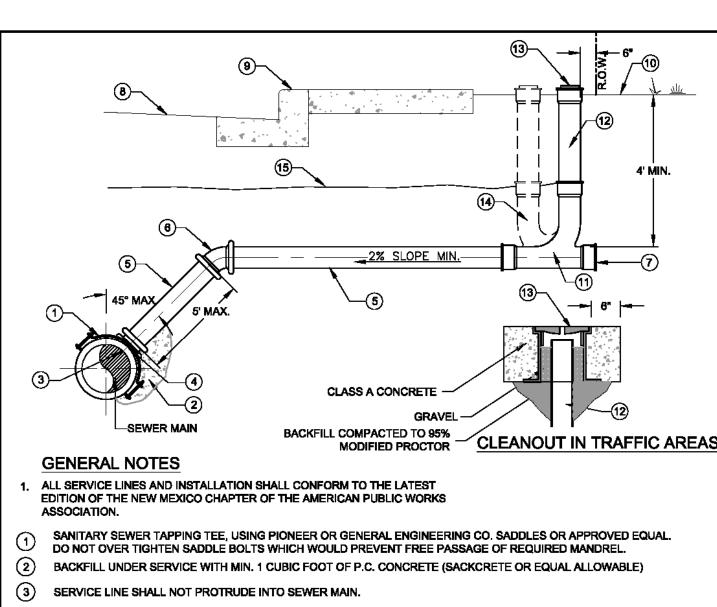

(4) CORE DRILLED USING FOWLER QUICK-WAY DRILL SYSTEM, OR PILOT HOLE CUTTER SYSTEM, OR APPROVED EQUAL

(5) 4" SERVICE LINE, CAST IRON SOIL PIPE (SERVICE WEIGHT), PVC SCHEDULE 40, OR ABS SCHEDULE 40

6 22.5° OR 45° BEND

7 PLUG OR CAP

9) STAMP OR CHISEL A "S" (3 INCHES HIGH AND 1/4 INCH DEPTH) INTO TOP OF CURB SURFACE AT EACH SERVICE LATERAL

10 FINISHED GRADE (11) WYE

(12) 4" PVC RISER

CONCRETE ENCASED TRAFFIC RATED SEWER CLEANOUT FRAME AND COVER ASSEMBLY (LBIW LB 1240/X-510A OR APPROVED EQUAL). PVC CAP IN NON TRAFFIC AREAS


(14) OPTIONAL DOUBLE WYE ASSEMBLY (4" PVC RISER & PVC CLEAN OUT)


CONSTRUCTION DETAILS & SPECIFICATIONS


(15) WARNING TAPE


SCALE: NTS SEWER LATERAL DETAIL DATE REVISIONS
12/20/11 TRAFFIC RATED CLEANOUT

HObbs CITY OF HOBBS ENGINEERING DEPARTMENT **CONSTRUCTION DETAILS & SPECIFICATIONS** 

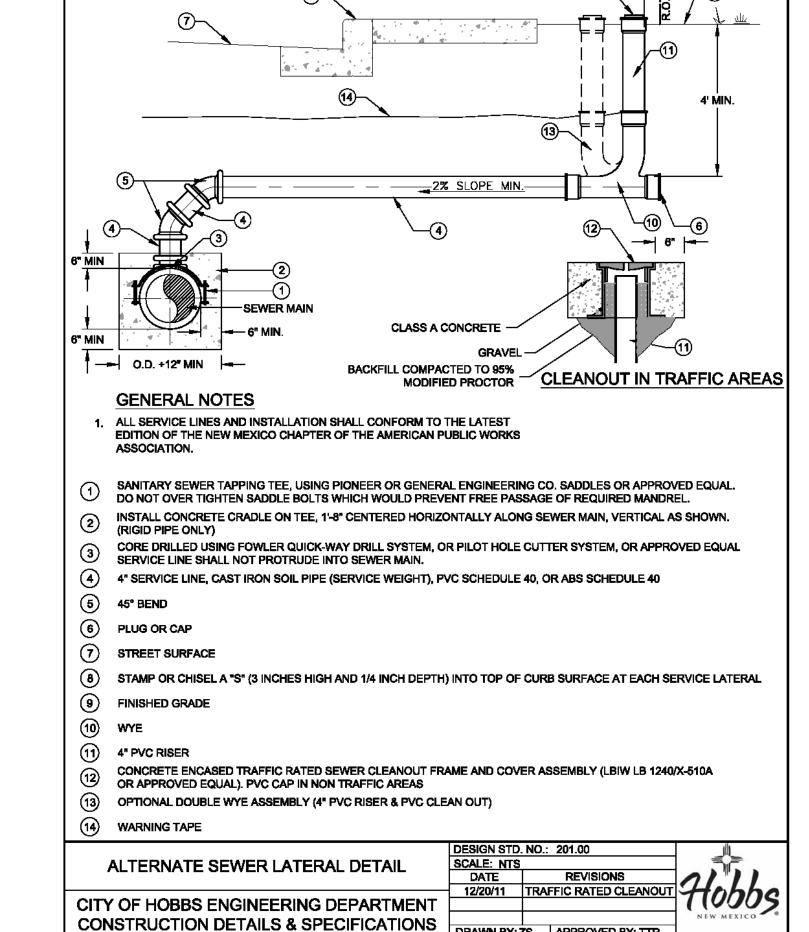


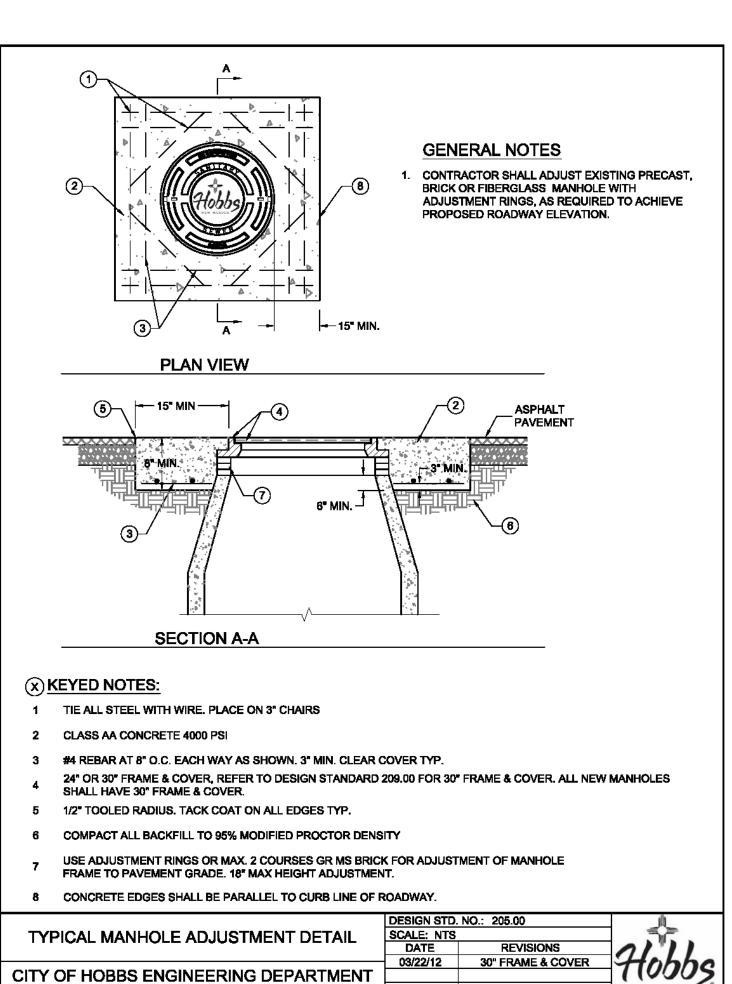

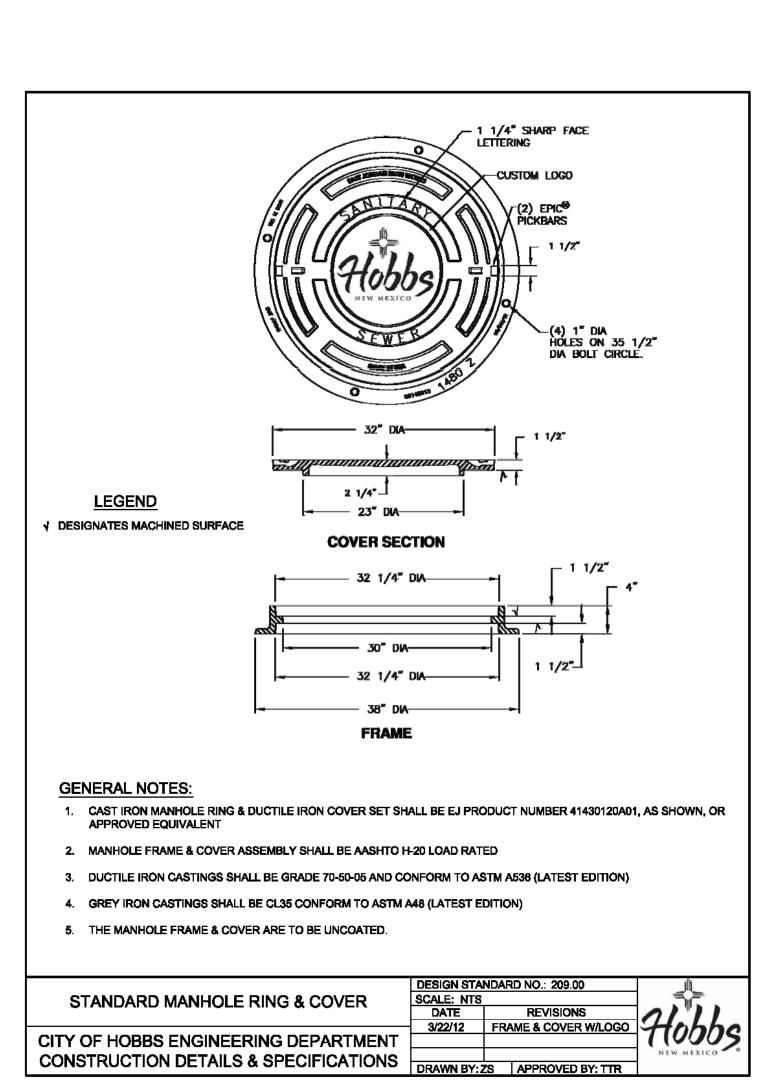


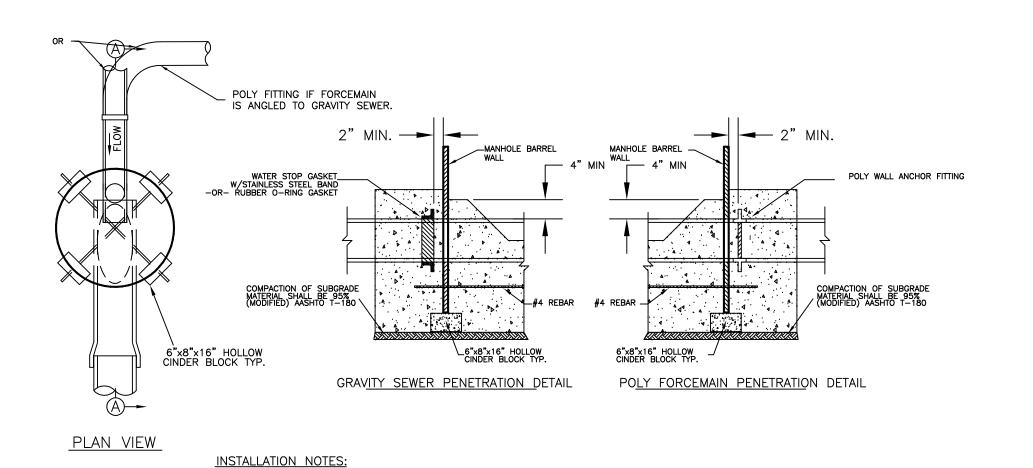

% MODIFIED PROCTOR. AASHTO T-180

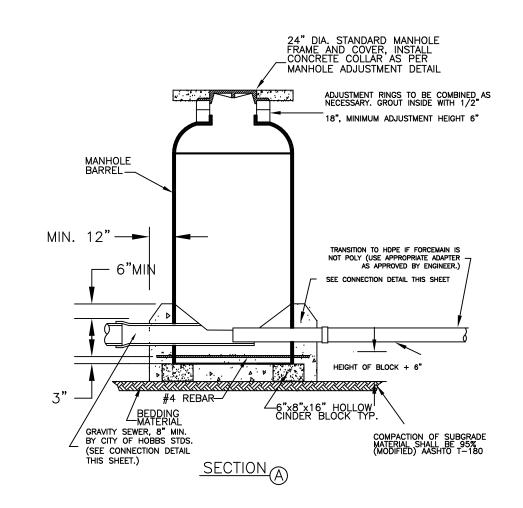


FORCE MAIN TO GRAVITY SEWER INSIDE EXIST. OR PROPOSED MANHOLE NOT TO SCALE

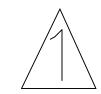


NO.	DATE	REVISIONS:	BY	CH	CHK ENGR
	9/24/19	ADDED FORCEMAIN TO MANHOLE DETAIL	SMM	SMM PLR PLR	PLR
<u>2</u>					
3					
4					
\$					

	Table 1
Drawn By:	Checked by
SMM	PLR
Date:	Disk:
6/20/19	GENERAL
File Name:	Job No.:
SEWER	
СН	FFT

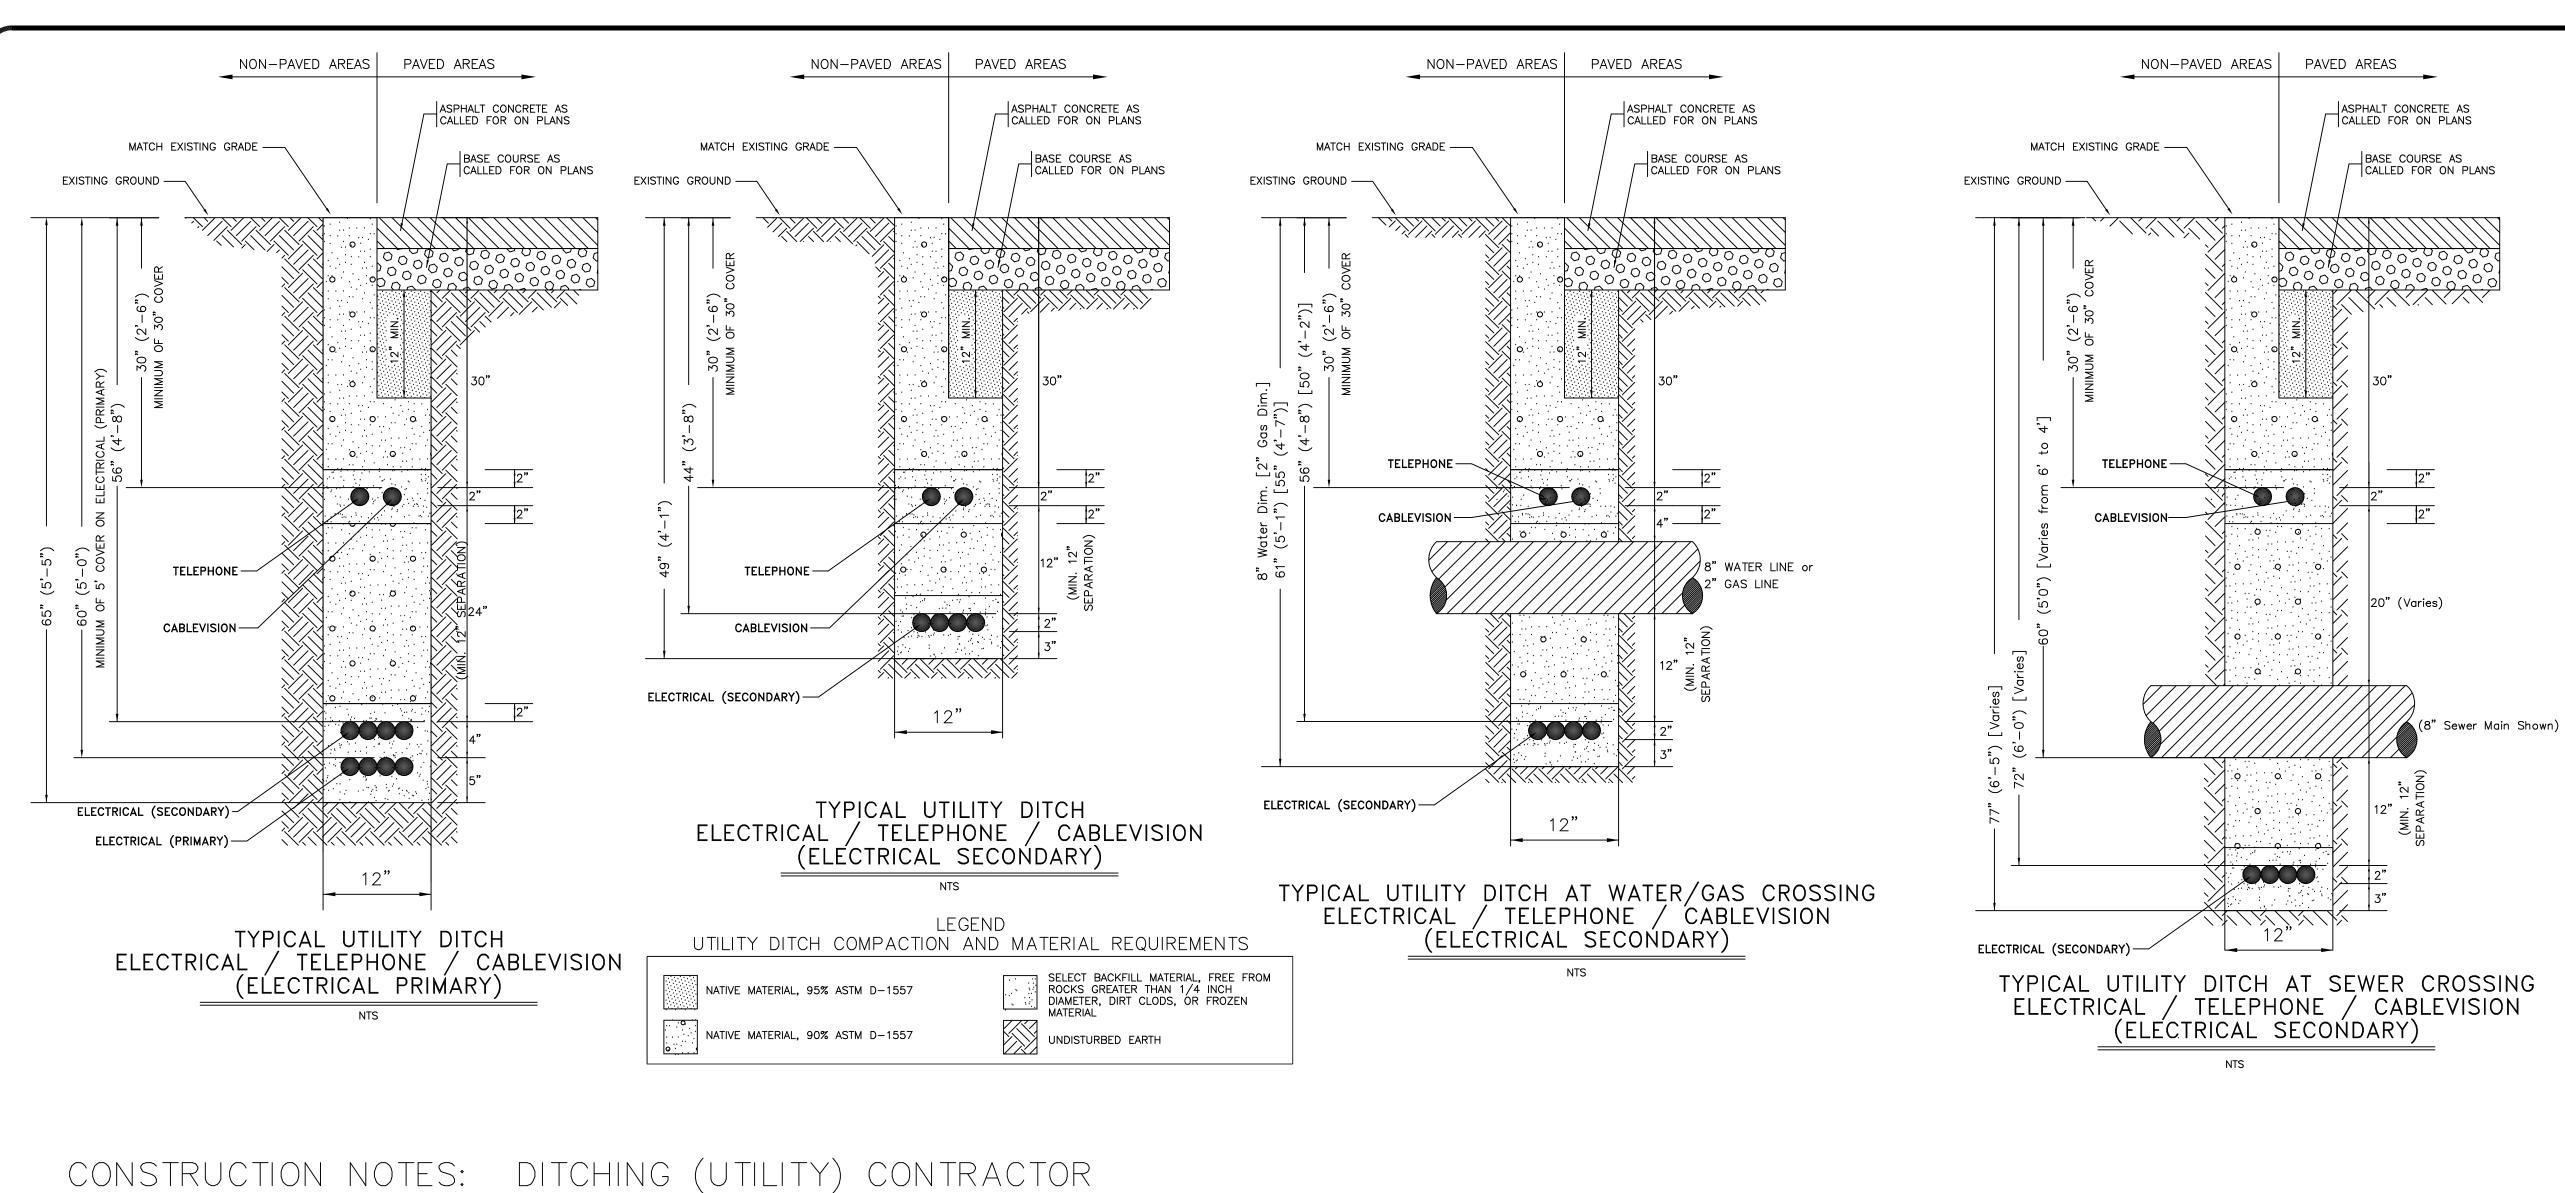


- 1. DITCHES, BACKFILL MATERIALS, BACKFILL & COMPACTION PROVIDED BY DITCHING CONTRACTOR.
- 2. DITCHING CONTRACTOR SHALL BE RESPONSIBLE FOR COORDINATING WITH ALL UTILITY OWNERS AND FOR THE PROTECTION OF ALL FACILITIES AFTER THEIR INSTALLATION. IF APPLICABLE, GAS COMPANY SHALL DITCH, INSTALL, BACKFILL AND COMPACT THEIR OWN UTILITIES.
- 3. ANY UTILITIES DAMAGED BY THE DITCHING CONTRACTOR DURING TRENCHING, COMPACTION, OR INSTALLING SERVICE LATERALS SHALL BE REPAIRED AND/OR REPLACED AT THE EXPENSE OF THE DITCHING CONTRACTOR.
- 4. EXTRA DEPTH NECESSARY FOR THE ELECTRICAL PRIMARY AND SECONDARY TO CROSS UNDER WATER or SEWER LINES AS SHOWN IN THE TYPICAL DETAILS IS CONSIDERED INCIDENTAL AND NO EXTRA PAYMENT WILL BE MADE.
- 5. ELECTRICAL CONDUIT REQUIRES A MINIMUM RADIUS OF 48 inches FOR ANY BRANCHES / BENDS. CONTRACTOR SHALL PROVIDE ADEQUATE DITCH WIDTH TO ACCOMMODATE THE NECESSARY MINIMUM RADIUS OF 48 inches REQUIRED AT ALL BRANCHES / BENDS FOR ELECTRICAL CONDUIT. THIS WILL BE CONSIDERED INCIDENTAL TO THE CONTRACT AND NO ADDITIONAL PAYMENT WILL BE MADE.

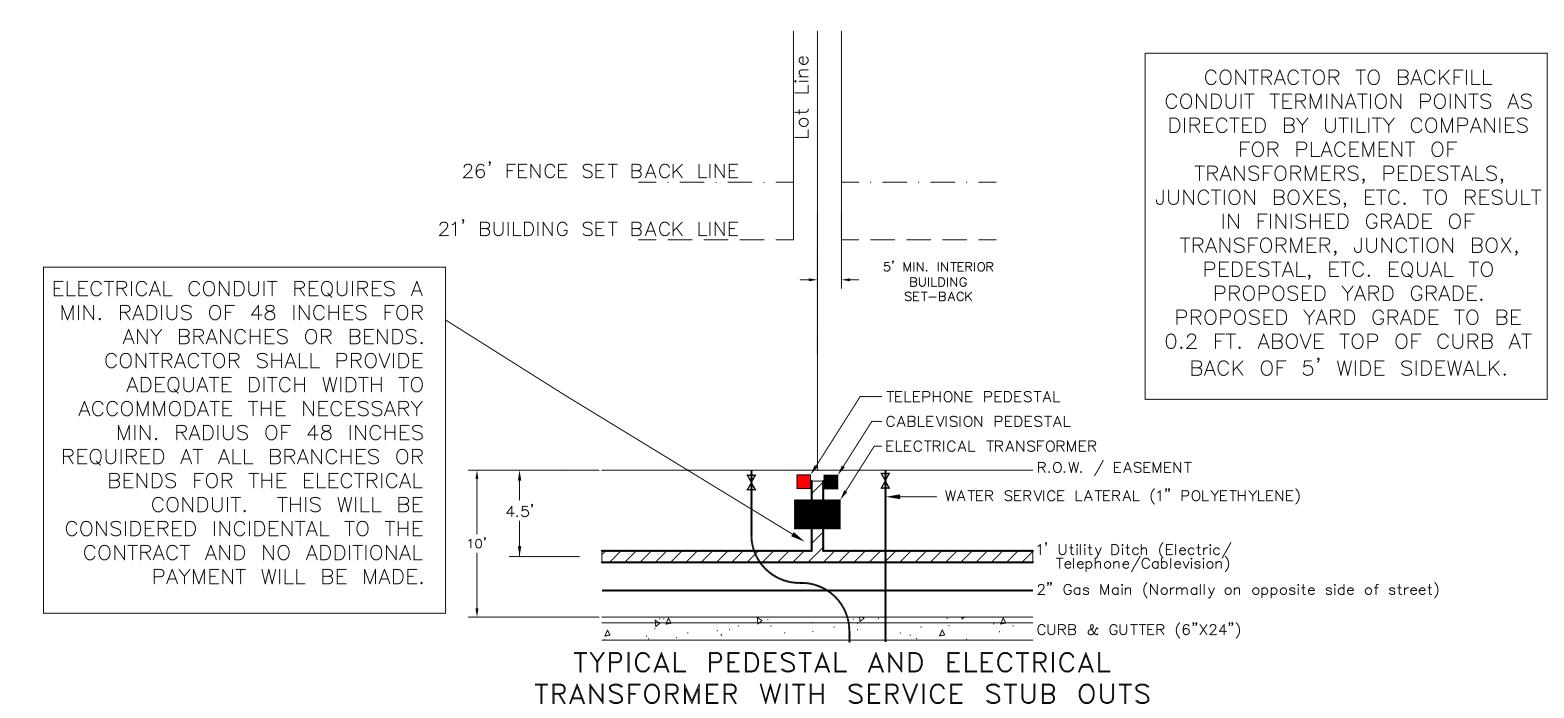

### NOTE:

SEWER LATERALS TO BE INSTALLED IN THE CENTER OF THE LOT, WATER SERVICES TO BE INSTALLED WITHIN 5' OF LOT LINES.

OWNER'S REPRESENTATIVE WILL INSTRUCT CONTRACTOR IF CHANGES IN THESE GUIDELINES OCCUR DUE TO HOUSING CONTRACTOR'S NEEDS.

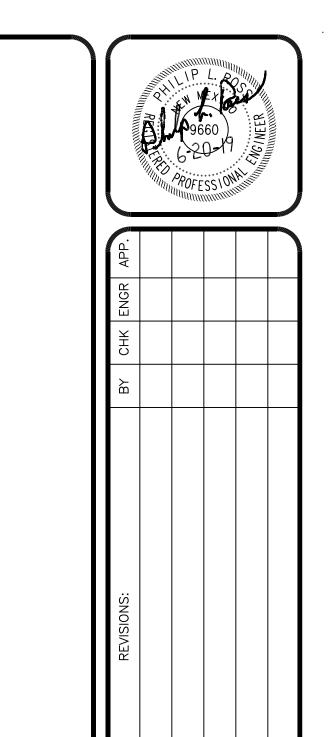

ALJO DEVELOPMENT, I TANGLEWOOD UNIT I MISCELLANEOUS DETAILS UNDERGROUND UTILITY D

Drawn By: |Checked I PLR File Name: Job No. MISC

SHEET 18

### October 15, 2019 Planning Board Regular Meeting




# SUBDIVISION PLANS ZIA CROSSING, UNIT 7

CITY OF HOBBS LEA COUNTY, NEW MEXICO NE/4 OF SECTION 13, TOWNSHIP 18 SOUTH RANGE 37 EAST

### INDEXOFSHEETS

SHEET	DESCRIPTION
A1	COVER SHEET, INDEX OF DRAWINGS & LOCATION MAP
A2	GENERAL NOTES & MATERIALS SPECIFICATIONS
A3	PRELIMINARY PLAT PROVIDED BY FOUR CORNERS SURVEYING
A4	UTILITY LAYOUT PLAN
B1	ZIA CROSSING PARKWAY ROAD PLAN & PROFILE
B2	KING KELLY PLAN & PROFILE
B3	BIG CY PLAN & PROFILE
B4	MIGHTY ATOM PLAN & PROFILE
B5	MIGHTY ATOM CIRCLE PLAN & PROFILE
B6	THE COUNT PLAN & PROFILE
B7	BACKSTRETCH PLAN & PROFILE
1	INTERSECTION DETAILS
12	INTERSECTION DETAILS CONT.
13	INTERSECTION DETAILS CONT.
W 1	WATER DETAILS
R1	ROADWAY DETAILS
S1	SEWER DETAILS
U1	UNDERGROUND ELECTRIC/TELEPHONE/CABLE TRENCH LAYOUT (Provided by Xcel Energy)
U2	ELEC/TELE/CABLE TRENCH DETAILS & USPS CLUSTER BOX DETAILS

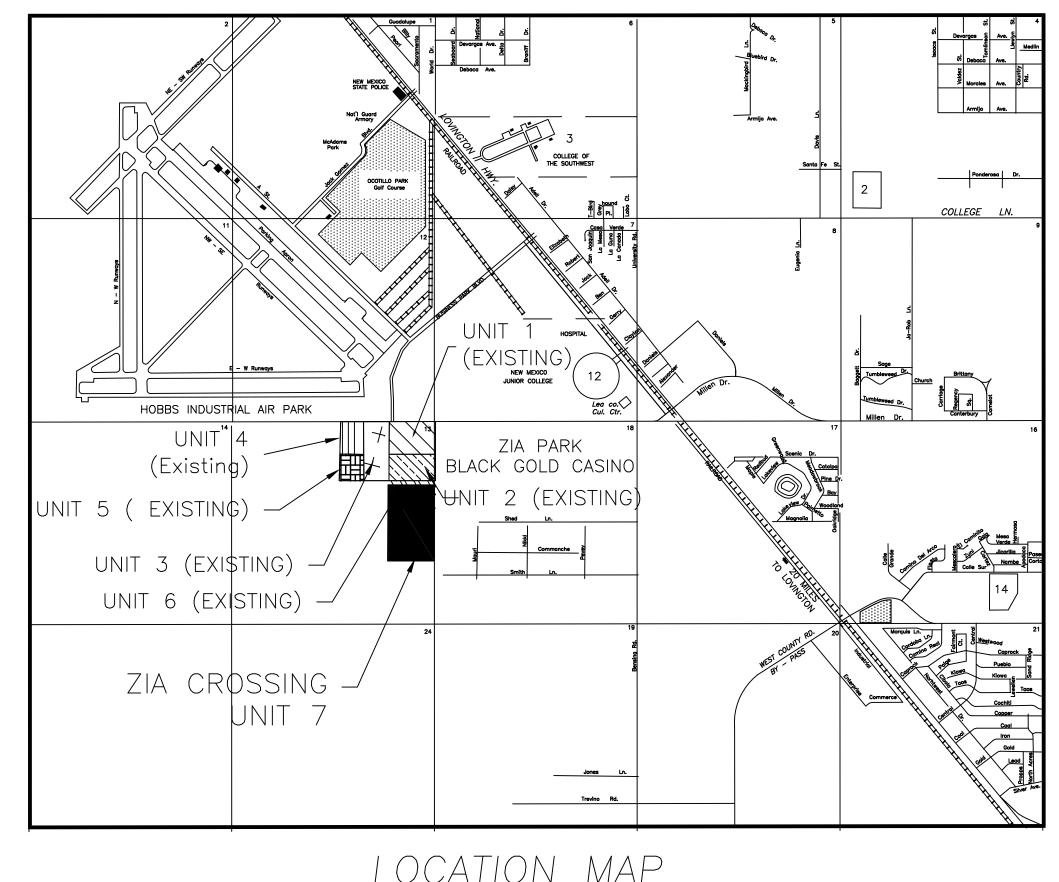

LOCATION MAP Not to Scale

### SPECIFICATIONS: Street Construction

- 1. All work shall meet or exceed the applicable requirements of the "New Mexico Standard Specifications for Public Works Construction" 1987 Edition (herein—after abbreviated NMSS), except as otherwise specified herein.
- 2. Earthwork shall be considered incidental to the street construction unless otherwise indicated in the bid proposal. All roots and other vegetation shall be removed from areas to be covered by asphalt or concrete. The subgrade shall be accurately shaped to lines and grades as indicated on the details. Minimum compaction in areas not otherwise shown shall be 90% of the maximum density as determined by ASTM D-1557, Method A.
- 3. All Portland Cement Concrete for pavement shall conform to NMSH&TD Specification— Section 451 or Section 503, for structures. The contractor shall submit a proposed job mix for the engineer's approval in ample time before placing any concrete.
- 4. Base course materials and placement shall conform to the requirements of NMSH&TD Specification, Section 304—Base Course. The contractor shall submit an aggregate analysis for the engineer's approval in ample time before placing any base course material.
- 5. Prime coat material and placement shall conform to the requirements of NMSH&TD Specifications, Section 408—Prime Coat. The contractor shall submit certification of quality for his proposed material for the engineer's approval in ample time before placing any prime coat.
- 6. Asphaltic concrete surface course material and placement shall conform to the requirements of NMSH&TD Specification, Section 420 OR 422—Plant Mix Bituminous Pavement (Dense Graded or Super Pave). The contractor shall submit a proposed mix design for the engineer's approval in ample time before placing any surface course.
- 7. The water and sewer contractor shall complete his work, including trench compaction and clean—up, in any one street before the paving contractor starts final subgrade preparation for the street construction. Final adjustment to grade of valve boxes and manhole covers, pouring concrete collars, etc., shall be left for the paving contractor.
- 8. All construction, including compaction, shall be guaranteed for a period of 12 months after completion of construction.

### <u>SPECIFICATIONS — Water and Sewer Systems</u>

- 1. All work shall meet or exceed the applicable requirements of the "New Mexico Standard Specifications for Public Works Construction", 1987 Edition (herein-after abbreviated NMSS), except as otherwise specified herein.
- 2. Manufacturer's brochure cuts, and certificates of quality where applicable, shall be submitted for the engineer's approval for all items installed on the job.
- 3. Water mains shall be PVC Water Pressure Pipe, Class 150, DR 18, C-900 water pipe as specified in NMSS Section 121, joints may be either mechanical or push—on type except where otherwise specifically indicated, or shall be Polyethylene Water Pressure Pipe, DR 17 as specified by AWWA C-906.
- 4. The use of tapping sleeves for connection to existing mains or repair sleeves will not be permitted except with the express permission of the engineer for each instance.
- 5. Water service lines shall be 1" diameter, polyethylene tubing and accessories shall conform with NMSS Section 560.2 Water Service Pipe.
- 6. All sections of new water mains shall be hydrostatically tested in accordance with AWWA C-600, Sec. 13, in the presence of the engineer and a city representative. The contractor shall furnish all equipment and labor required to make the tests. The mains shall be tested with the service connections complete in place. The leakage shall not exceed the calculated allowable leakage as specified in test sheet 801.16.2 in NMSS Section 801. The contractor shall locate and repair all leaks until there are no visible leaks and the overall leakage is within the specified maximum.
- 7. Sanitary sewer pipe shall be Polyvinyl Chloride (PVC) pipe, DR 35, as specified in the NMSS Section 121.
- 8. Manholes shall be constructed with precast reinforced concrete sections conforming to ASTM C-478. Block manholes are expressly prohibited. All portland cement concrete and mortar used in manhole construction shall utilize Type II cement. Care shall be taken to properly finish manhole inverts.
- 9. The water and sewer contractor shall complete his work, including trench compaction and clean—up, in any one street before the paving contractor starts final subgrade preparation for the street construction. Final adjustment to grade of valve boxes and manhole covers, pouring concrete collars, etc., shall be left for the paving contractor.
- 10. All watermains shall be chlorinated as specified in NMSS Section 801.17. Each service connection shall be operated to thoroughly flush the lines on completion.
- 11. All construction, including compaction, shall be guaranteed for a period of 12 months after completion of construction.
- 12. All service line connections for water and sewer shall be made with fittings specifically for the material used, and as per the manufacturer's installation requirements.

### NOTES — Water and Sewer Construction

- 1. Sewer services shall be located 5 feet <u>+</u> down—stream from the center of the lot frontage except where otherwise indicated on the plans. Opposing connections shall be spaced at least 4 feet apart along the sewer mains. Water services shall be located 5 feet <u>+</u> upstream from the common lot lines except where otherwise indicated on the plans, and 10 feet minimum away from the sewer services. Water taps shall be spaced at least 2 feet apart on the water mains.
- 2. Stationing is as shown on the plan and profile sheets.
- 3. Water mains shall not be located less than 10 feet away from sewer lines nor closer than 3 feet to the lip of the curb and gutter, except where lines cross.
- 4. Where a water line passes beneath or less than 18 inches above a sewer line, the sewer line shall be encased in concrete 6 inches thick as shown in the "Standard Details" for at least 10 feet on each side of the water line, or the sewer line shall be Ductile or Cast Iron Pipe with pressure—type joints for 10 feet on each side of the water line. This shall also apply where a parallel water line is less than 10 feet horizontally and less than 2 feet above the sewer.

### GENERAL NOTES:

- 1. Testing of construction materials, including subgrade compaction, shall be performed as required by the engineer and at the expense of the owner, except that the contractor shall pay for any re—testing required. The contractor shall cooperate in allowing opportunity for testing and furnishing samples and job site assistance as required. The contractor shall furnish manufacturer's certificates of quality as required.
- 2. The contractor shall maintain a reasonably clean job site throughout the construction period and at completion shall remove all debris and dress up all areas disturbed by his operations.
- 3. Measurement and payment of the various items of construction shall be made by the units indicated in the bid proposal and at the unit prices bid, work and materials not specifically called out in the bid proposal shall be considered incidental to the nearest associated item listed in the proposal.
- 4. The contractor shall do his own layout and construction staking from bench marks and and centerline reference points furnished by the owner. The contractor shall be responsible for properly referencing all triangulation stations, bench marks, monuments, and grant markers, section corners, or other permanent reference marker, that may be destroyed during the construction of this project. The Project Manager, at the contractor's expense, shall reference and reset destroyed monuments according to government regulations and state law. Design survey for Owner provided by John West Surveying Company.
- 5. Haul shall be considered incidental to construction, and no direct payment shall be made.
- 6. For estimating purposes only, earthwork quantities are based on a shrinkage factor of 0% in roadway embankment and 0% swell in roadway excavation.
- 7. No underground utilities (water or sewer) shall be backfilled prior to inspection and approval by the ENGINEER. Any backfill placed prior to inspection and approval will be removed at the contractor's expense.
- 8. Locations of all existing utilities shown were taken from record drawings or field surveys and are located as accurately as possible from information available. It will be the contractor's responsibilitity to protect, maintain in service, and at points required, verify exact locations of these utilities during construction operations of this project.
- 9. The contractor shall never unnecessarily interfere with or interrupt the services of any public utility having property within or adjacent to the construction area. He shall give all public utility companies a reasonable notice in writing, in no event less than 48 hours, for any work that he contemplates would interfere in any what whatsoever with the service of any existing public utility and city—owned facility.
- 10. When construction under this project connects to existing improvements the contractor shall build an easy—riding connection.
- 11. When abutting new pavement to edges of existing pavement, the existing pavement shall be cut a straight neat edge and tack coat shall be applied to edges of existing pavement prior to beginning of new pavement operations.
- 12. The Contractor shall coordinate any work required by others in the construction area with the construction of this project.
- 13. No underground utilities (water or sewer) shall be backfilled prior to inspection and approval by the CITY OF HOBBS. Any backfill placed prior to inspection and approval will be removed at the contractor's expense.
- 14. Where proposed elevations in the plans are shown with two digits preceeding the decimal, it shall be assumed that 3600 feet is to be added.
- 15. All concrete shall contain fiber reinforcement. Fiber reinforcement shall be virgin polypropylene strands approximately 3/4 inches in length, mixed into the concrete at a rate of 1.5 pounds per cubic yard or fibers shall be Anti-Crack HD (AR glass fibers) as manufactured by Saint-Gobain Vetrotex America and mixed into the concrete at a rate of 1.0 pounds per cubic yard (fiber length 3/4 inch). Use of fiber reinforcement does NOT substitute for any structural reinforcement required by teh project drawings and contract documents. No separate measurement or payment will be made for fiber reinforcement, it shall be considered incidental to to the item being installed.
- 16. Construction will not be considered complete until all drainage structures, including new curband gutter, are tested flowing and found satisfactory by the project manager. Finished concrete grade tolerance shall not deviate from those shown on the plans by more than =/- 0.002 feet. This shall be considered incidental to the construction of this project.

### MATERIAL SPECIFICATION:

Materials and equipment used in the installation of water and sewer improvements shall be in accordance with the City of Hobbs standards and shall be new and unused, manufactured in compliance with standards published by the American Society for Testing and Materials (ASTM), the Americal Water Works Association (AWWA) or other published applicable standards.

Where specific items are called for by name, make, or catalog number such reference shall be interpreted as establishing a standard quality and not construed as limiting competition. The use of substitutes is permissible in most cases, provided written requires and proper certification are submitted to the ENGINEER for review and approval prior to Bid Opening for City of Hobbs approval.

### SANITARY SEWER

Collector: PVC, SDR 26 (under 18" Dia.) (Stiffness of 46 for over 18" Dia.), push—on, gasketed (or glued) sewer pipe. Service: PVC, SCH 40 or SDR 21, push—on, gasketed (or glued) sewer pipe.

Fittings: PVC, SCH 40, push—on, gasketed sewer pipe,

Manholes: Fiberglass (preferred) or Precast reinforced concrete, 4 ft. inside diameter, type "C" Concentric manholes.

Manhole rim and Lid:

A. Vented in pavement areas, East Jordan Iron Works #41430120A01 or approved equal.

Frame & cover shall be AASHTO H-20 load rated, Ductile Iron castings shall be grade 70-50-05 conforming to ASTM A536 (latest edition), Grey Iron castings shall be CL35 conforming to ASTM A48 (latest edition), frame & cover to be uncoated. (See Details)

B. Sealing in drainage swale and bar-dich areas, shall be as required by the City of Hobbs.

Force Mains: HDPE DR 13.4 C-906 (WPR 130 psi) or PVC DR 14 Class 200 C-900 (WPR 145 psi).

POTABLE WATER

Distribution Lines: PVC, DR 18, Class 150, C-900 push-on, gasketed water pipe — OR — HDPE, DR 17, C-906 blue or blue stripe.

Fittings: Mechanical joint (MJ), class 250 or 350 S.S.B. type, ductile iron pipe fittings for PVC. Polyethylene fittings may be MJ or fused fittings, ductile iron pipe sizes. All HDPE pipe shall utilize MJ adapters when connection to Ductile Iron Fittings. Mega Lug restraned fittings shall be used along with concrete thrust blocking. Valves may be FL X MJ when connected at fittings.

Gate Valves: Mueller bonded resilient seat, non-raising stem type, mechanical joint, fuse bonded epoxy coated inside and out, 2 inch operating nut, opens counter-clockwise. Valves may be FL x MJ when connected at fittings.

Fire Hydrants: Kennedy Guardian — K81D Main valve fire hydrant, Exterior painted "chrome yellow" as per NM APWA specs.

Valve Boxes: Tyler 461S, or equal

Water Meter Box — Regular Meter Box — EAst Jordan product number 32234002A04, round 18" x 18" and DFW Plastics Inc. plastic blue cover product number (18AMR—49).

PE P9660

10-1-19

PROFESS ION

MINIMULATION PROFESS ION

MINIMULATION

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BLACK GOLD DEVELOPM
ZIA CROSSING UNIT 7
GENERAL NOTES AND
MATERIALS SPECIFICATI

the ROSS
GROUP
CONSULTING ENGINEERS
410 N. DAL PASO
HOBBS, NEW MEXICO 88240

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SIZE

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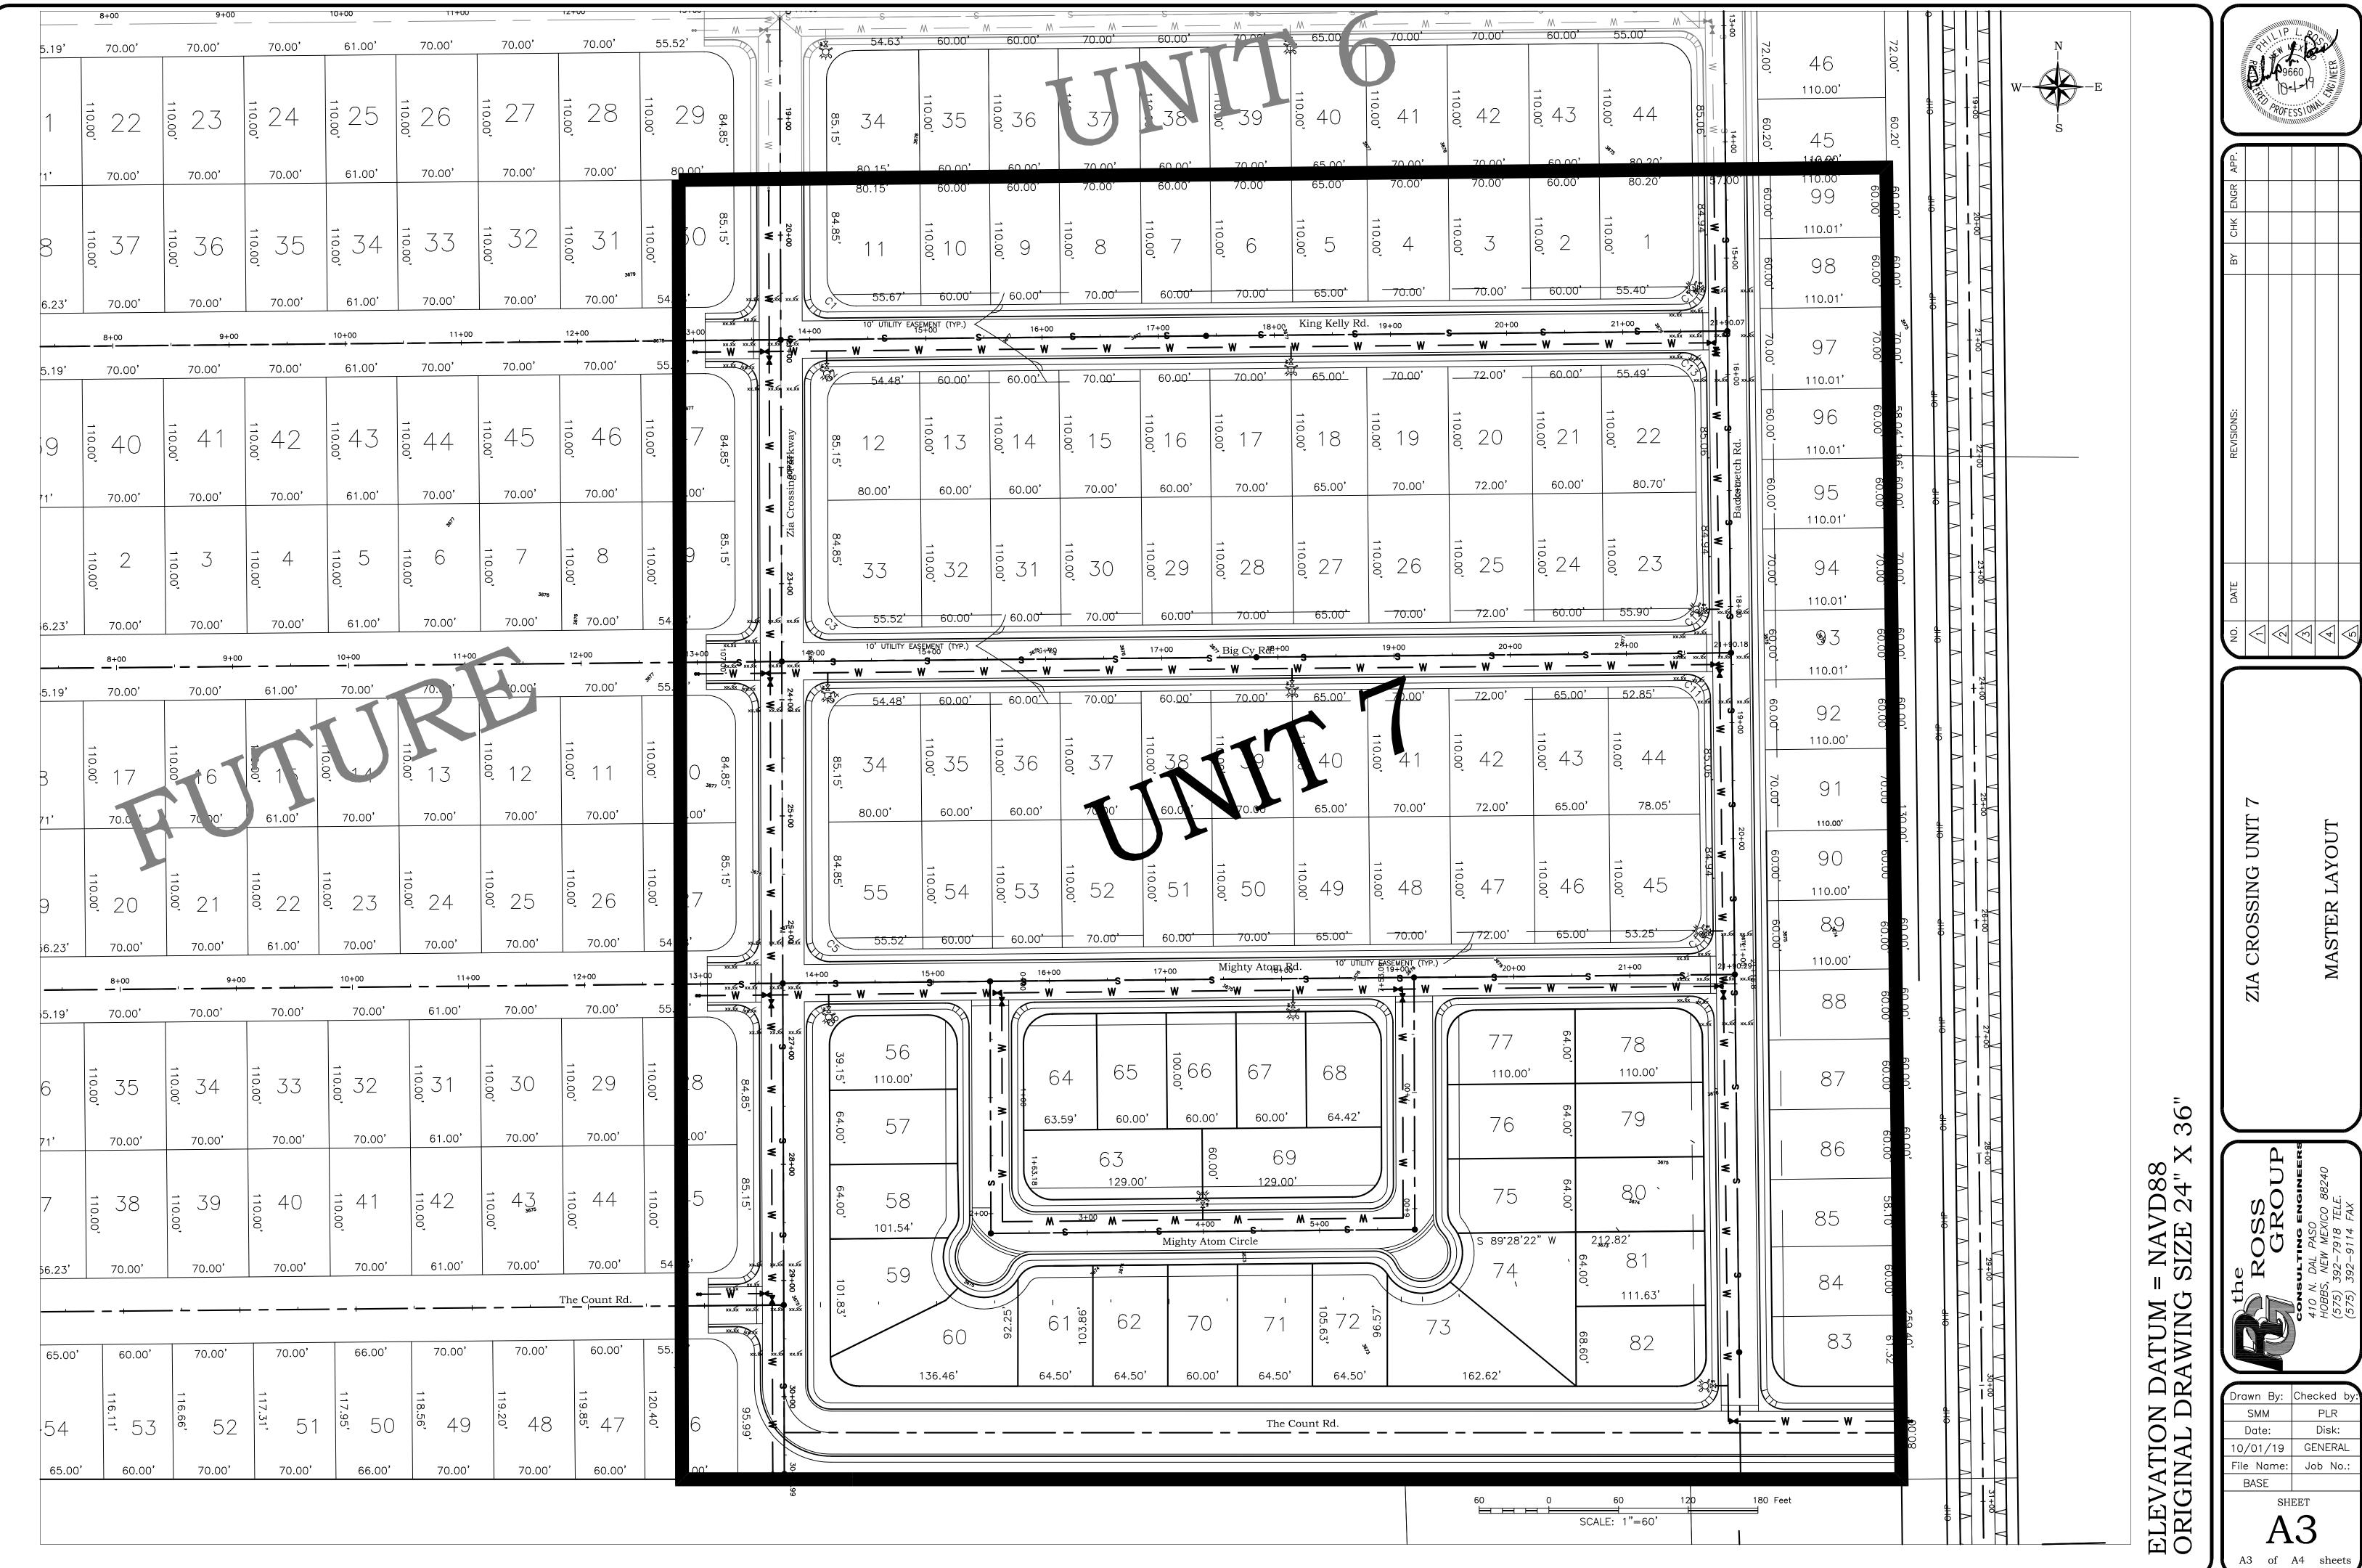
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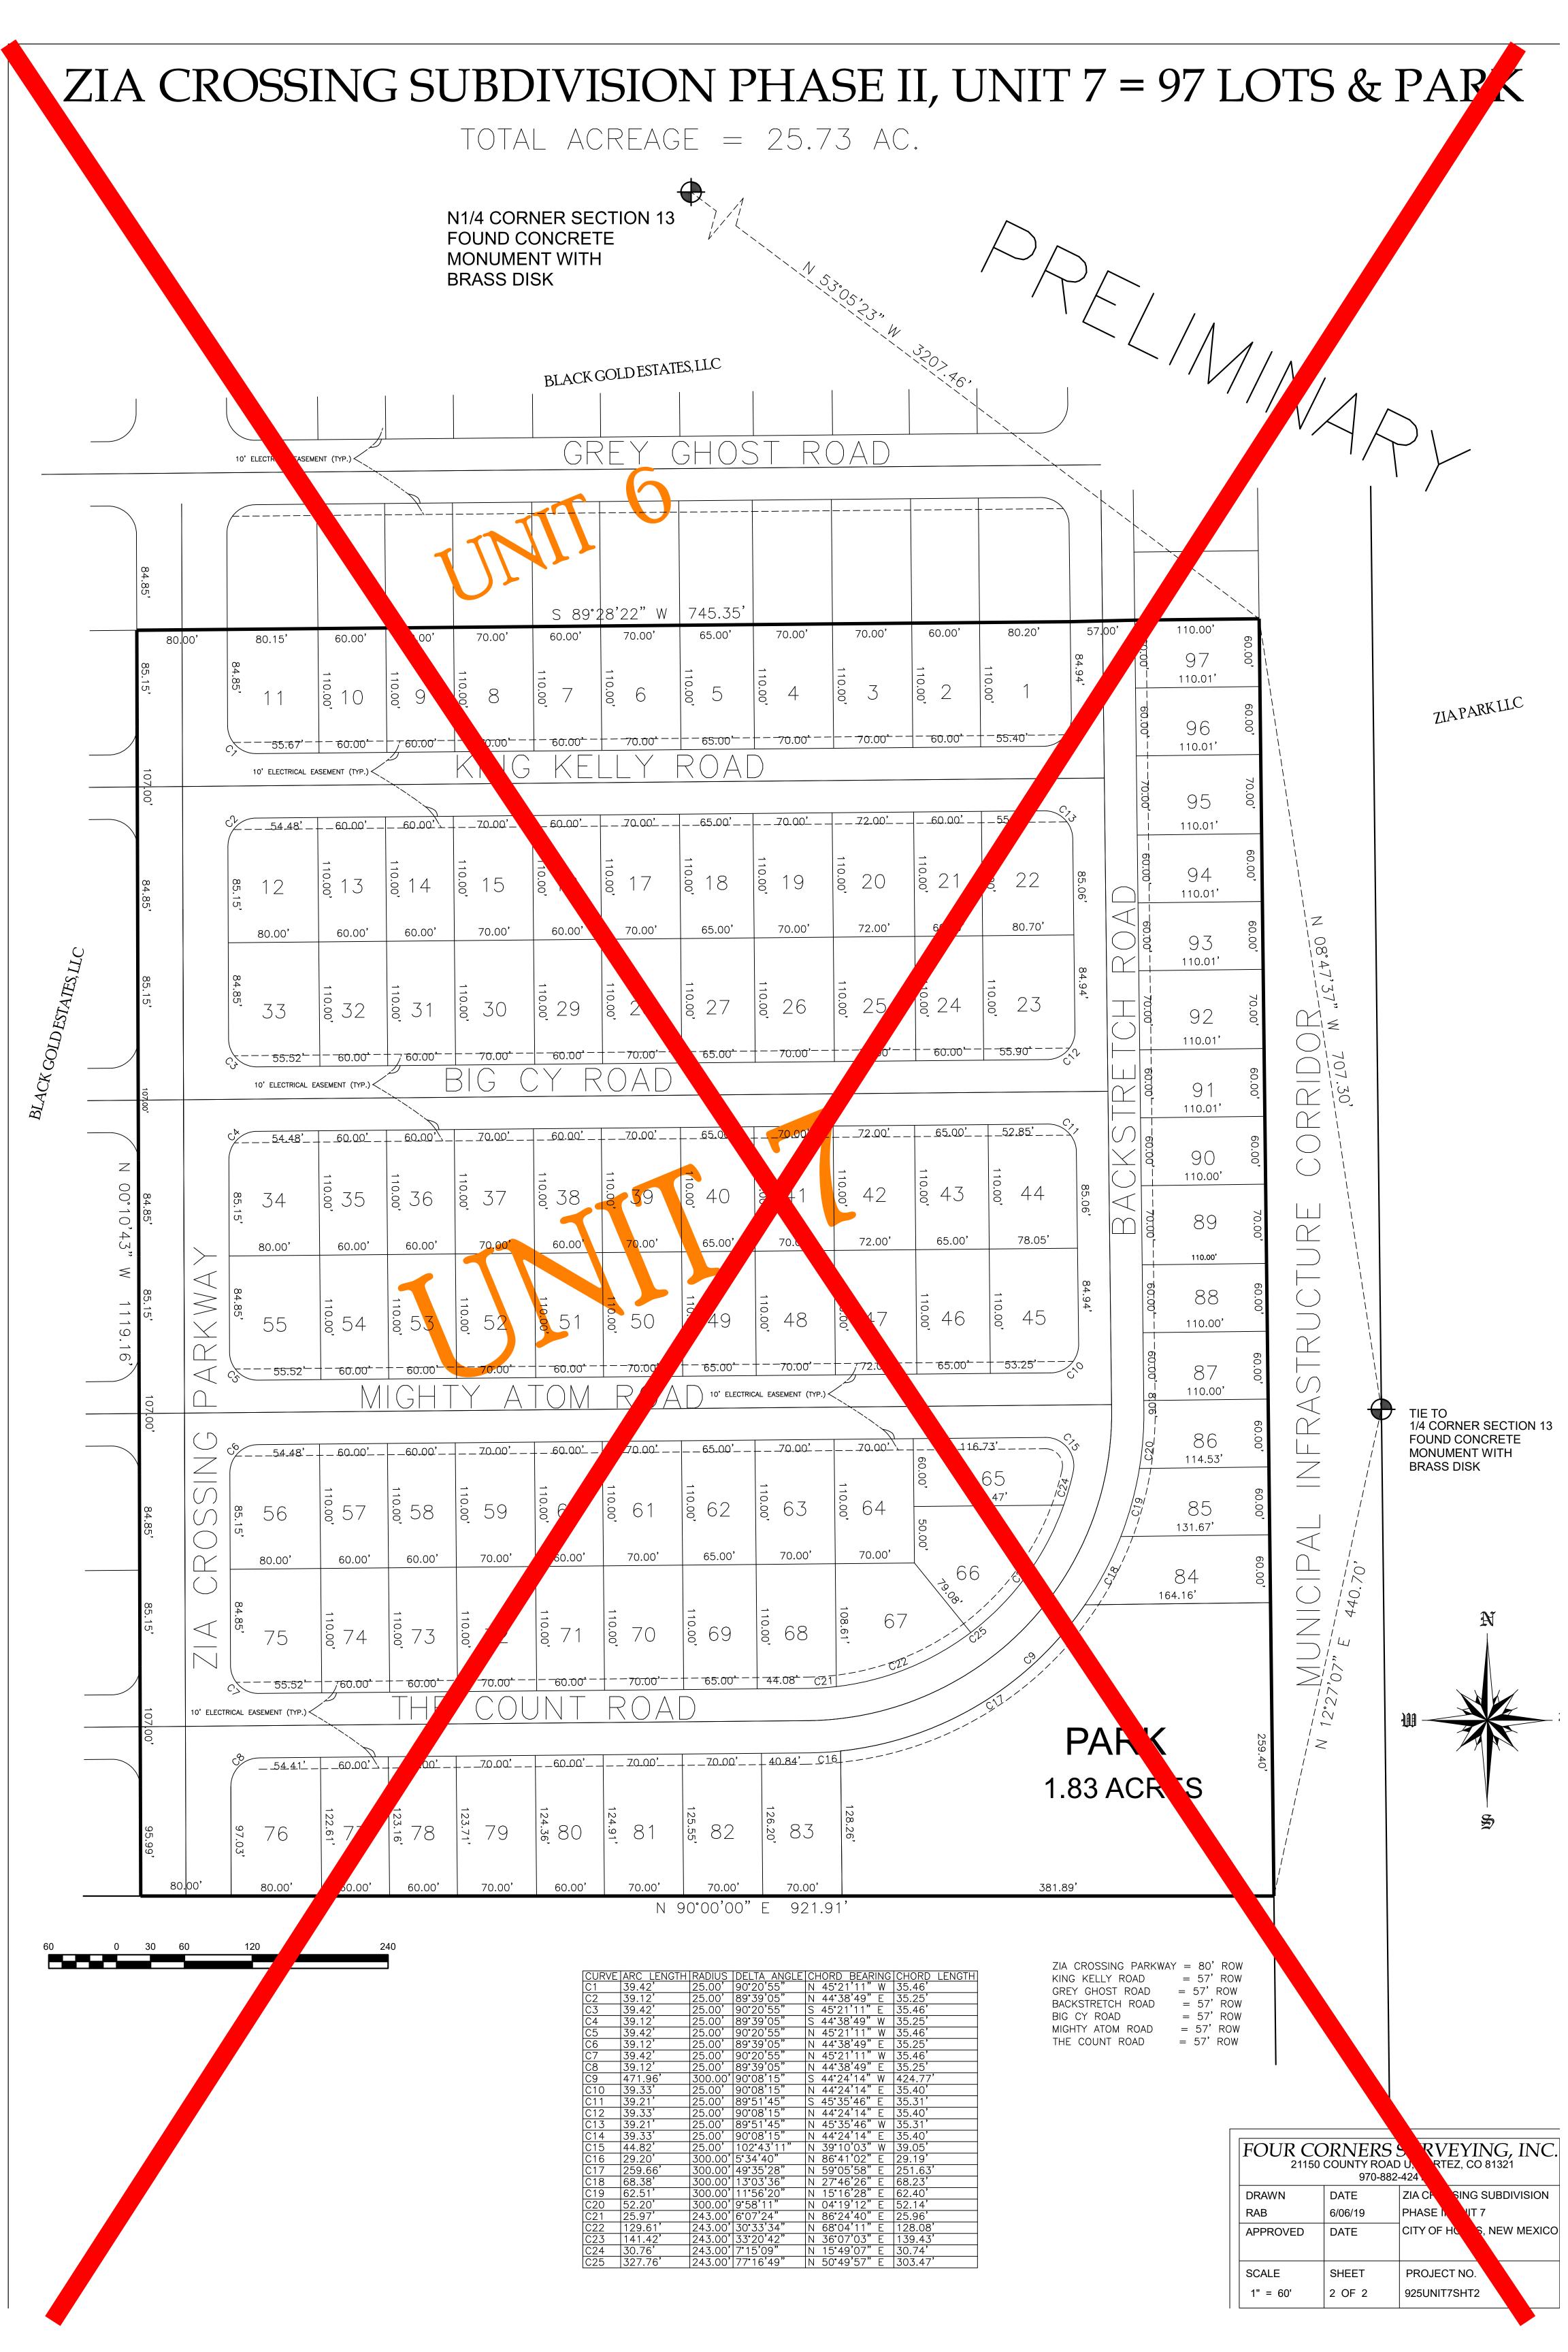
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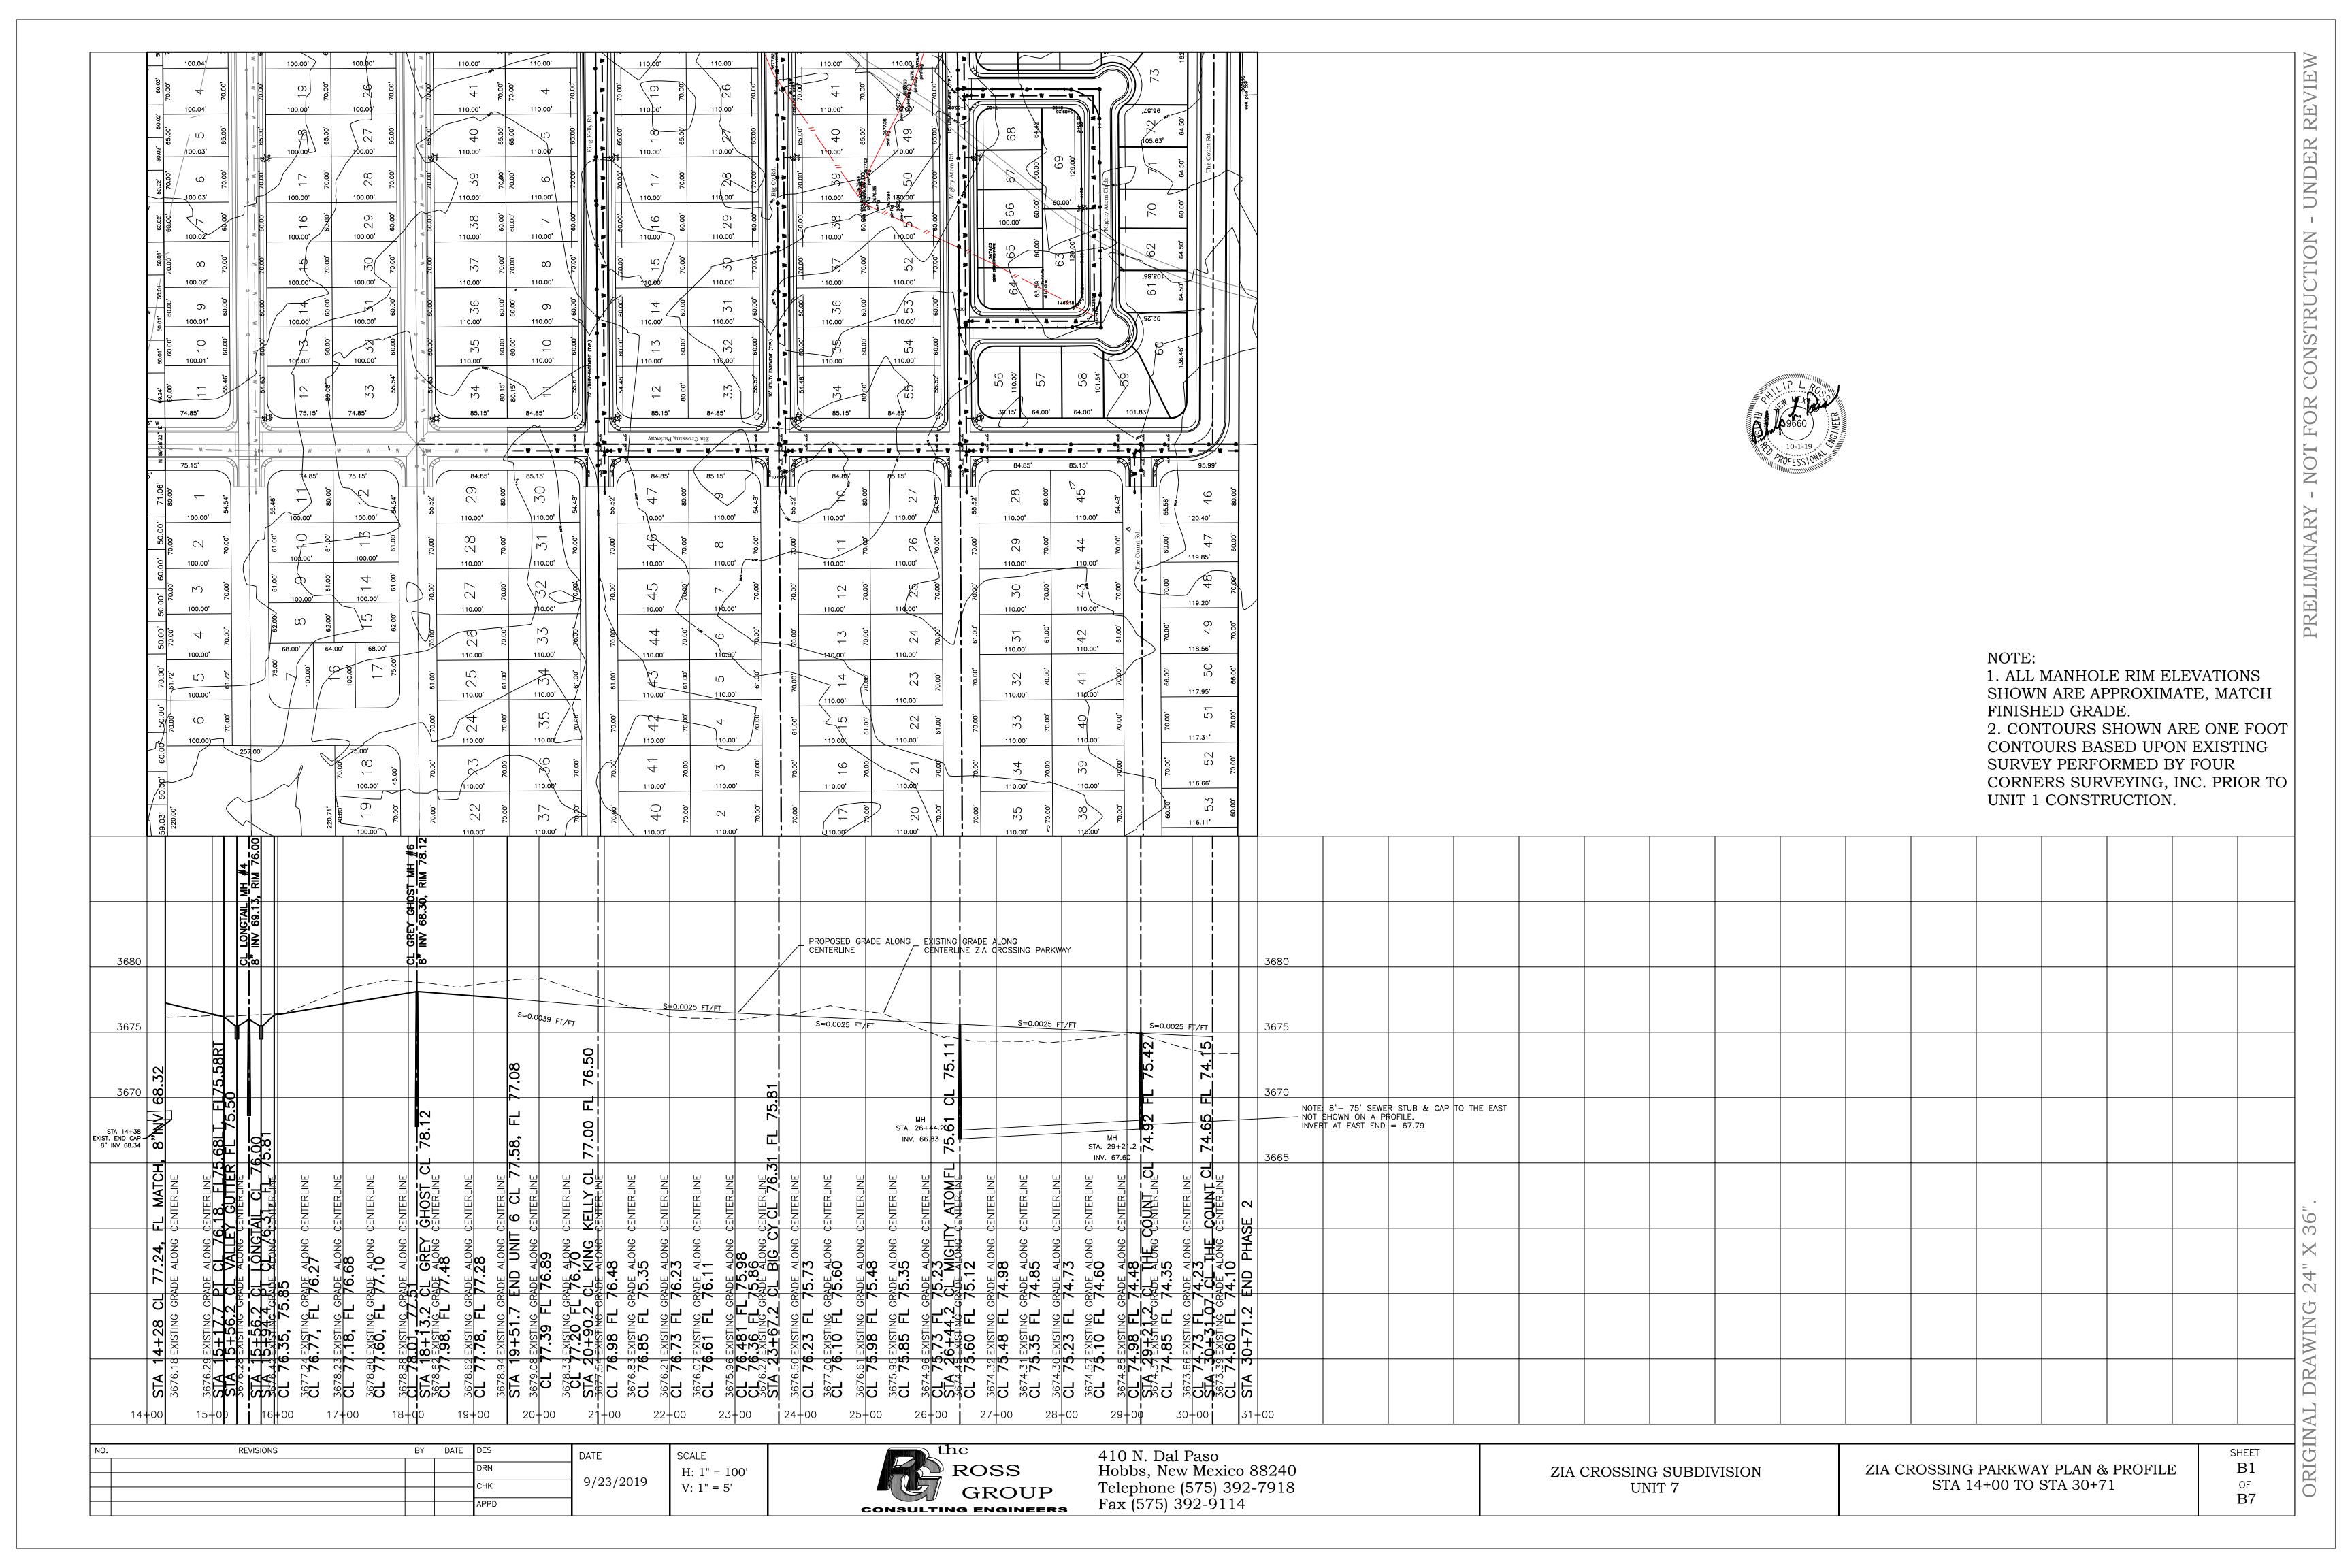
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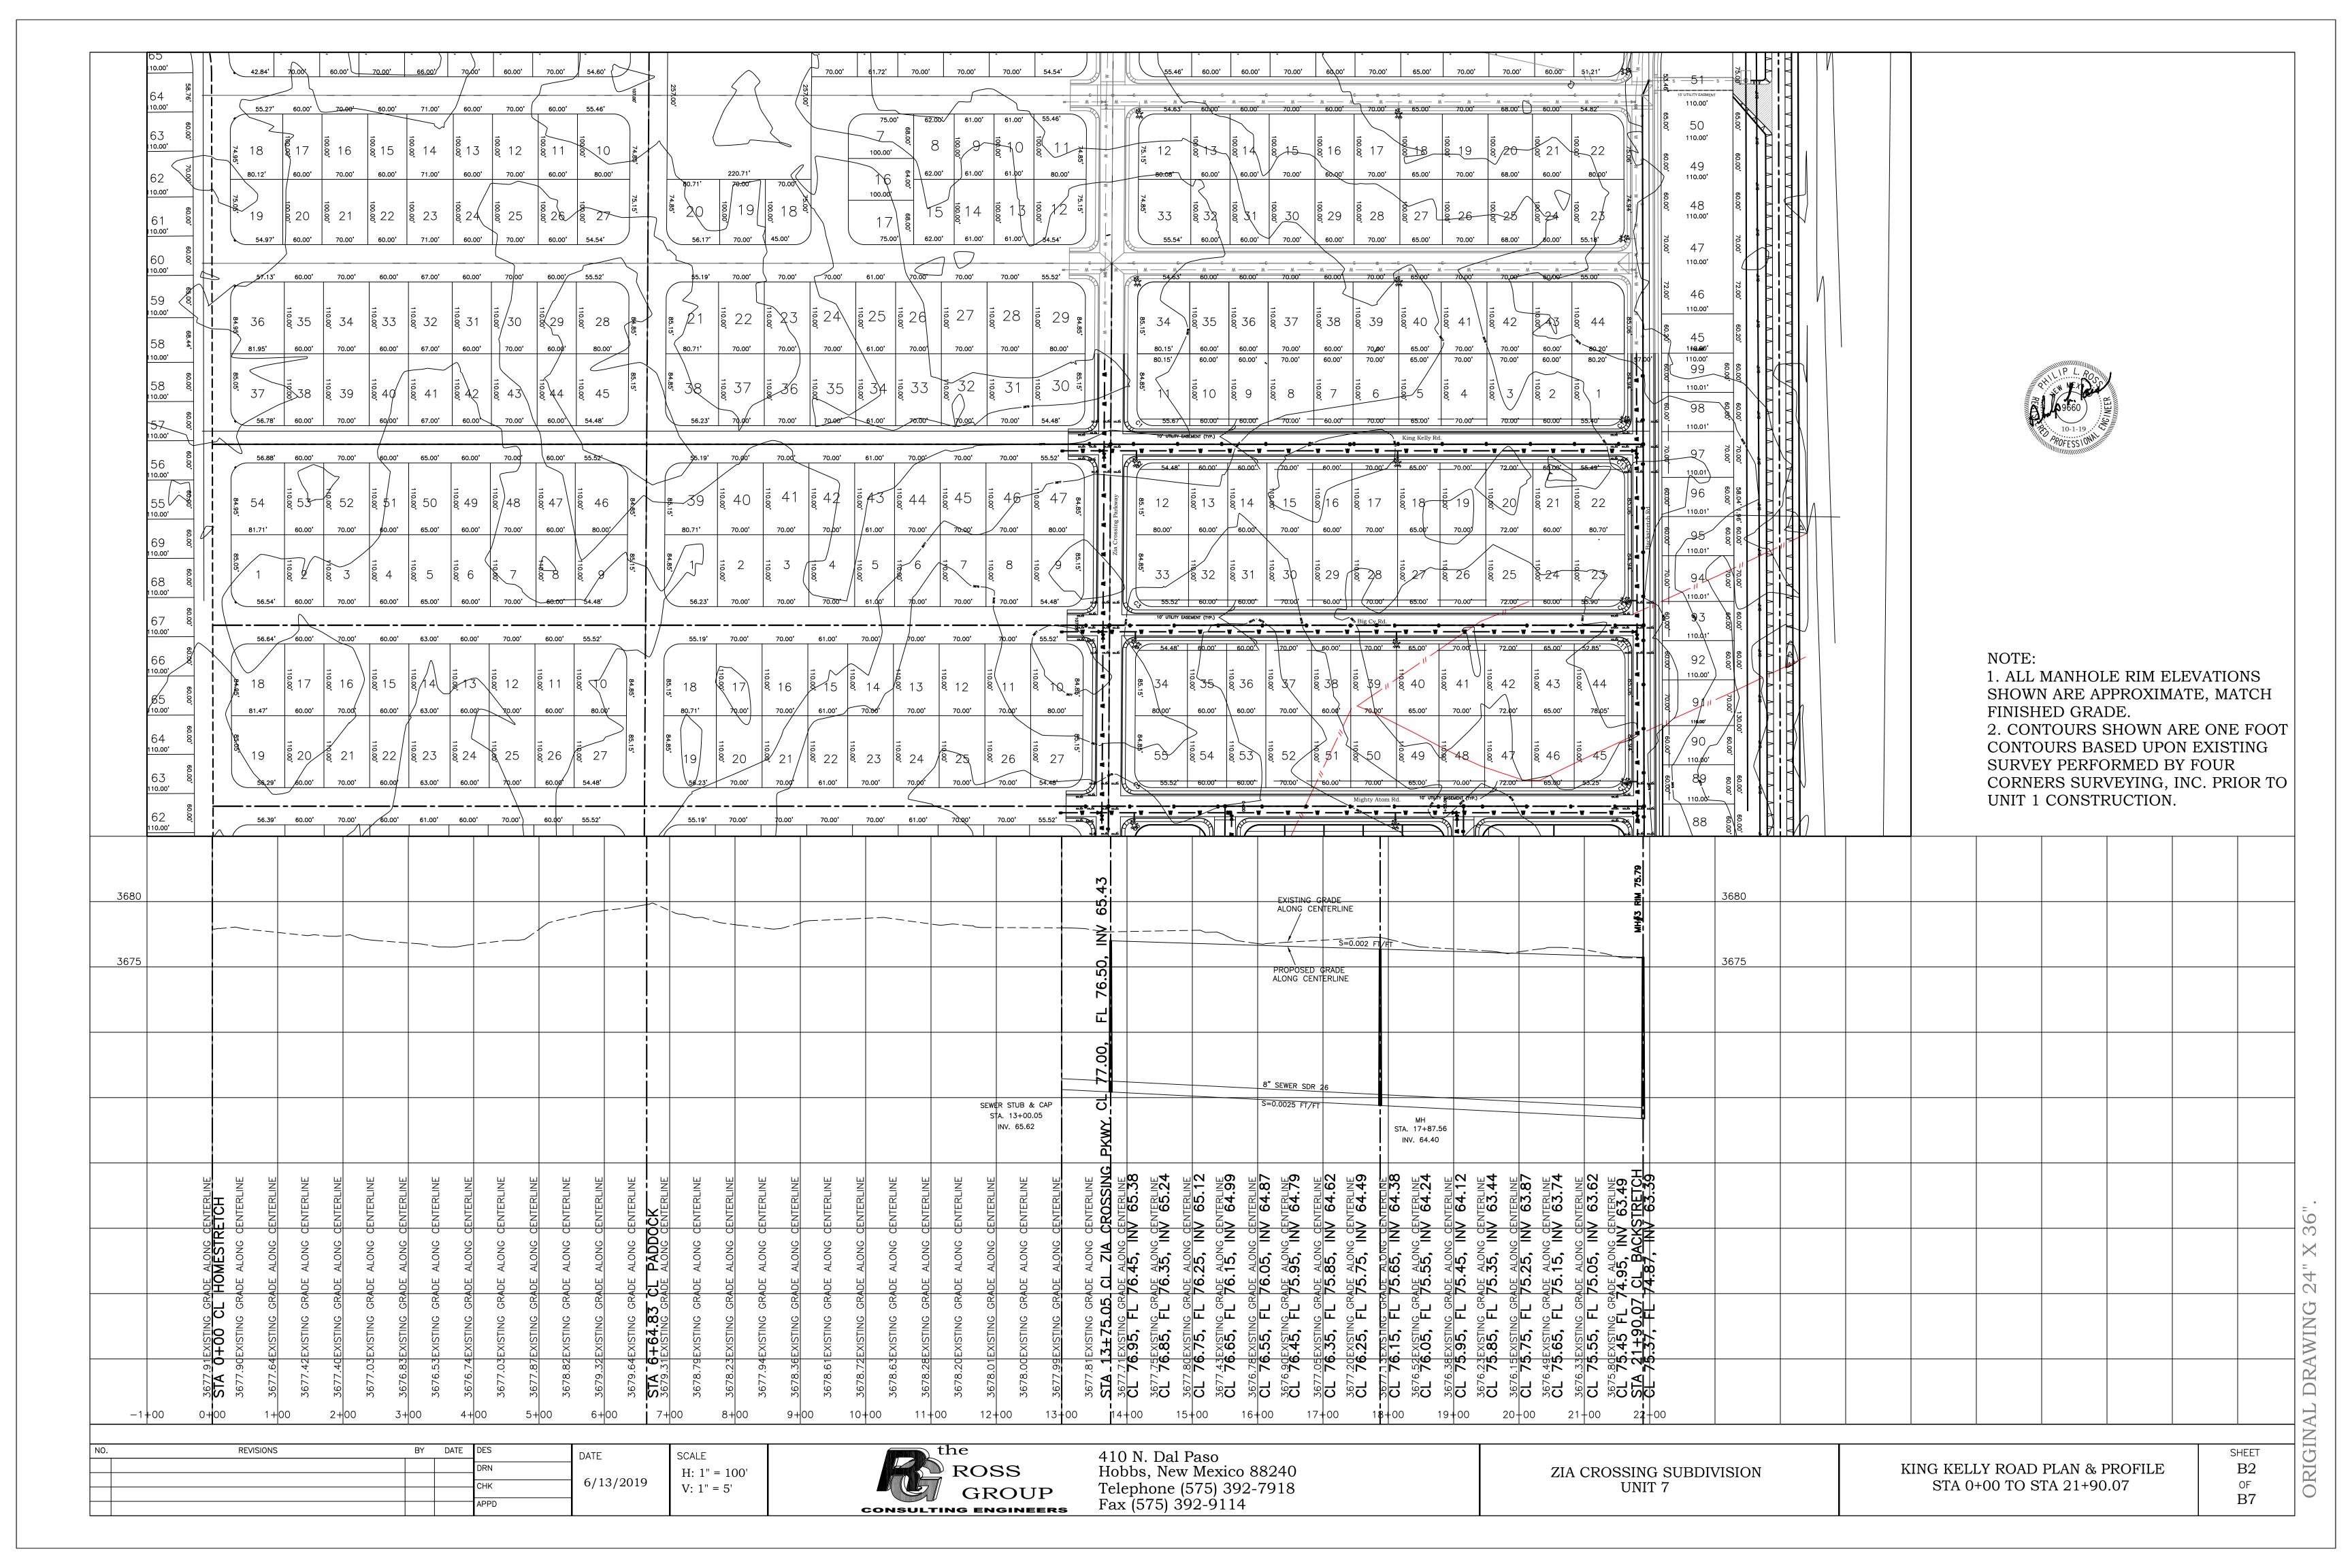
SHEET A2 of A4 sheets
















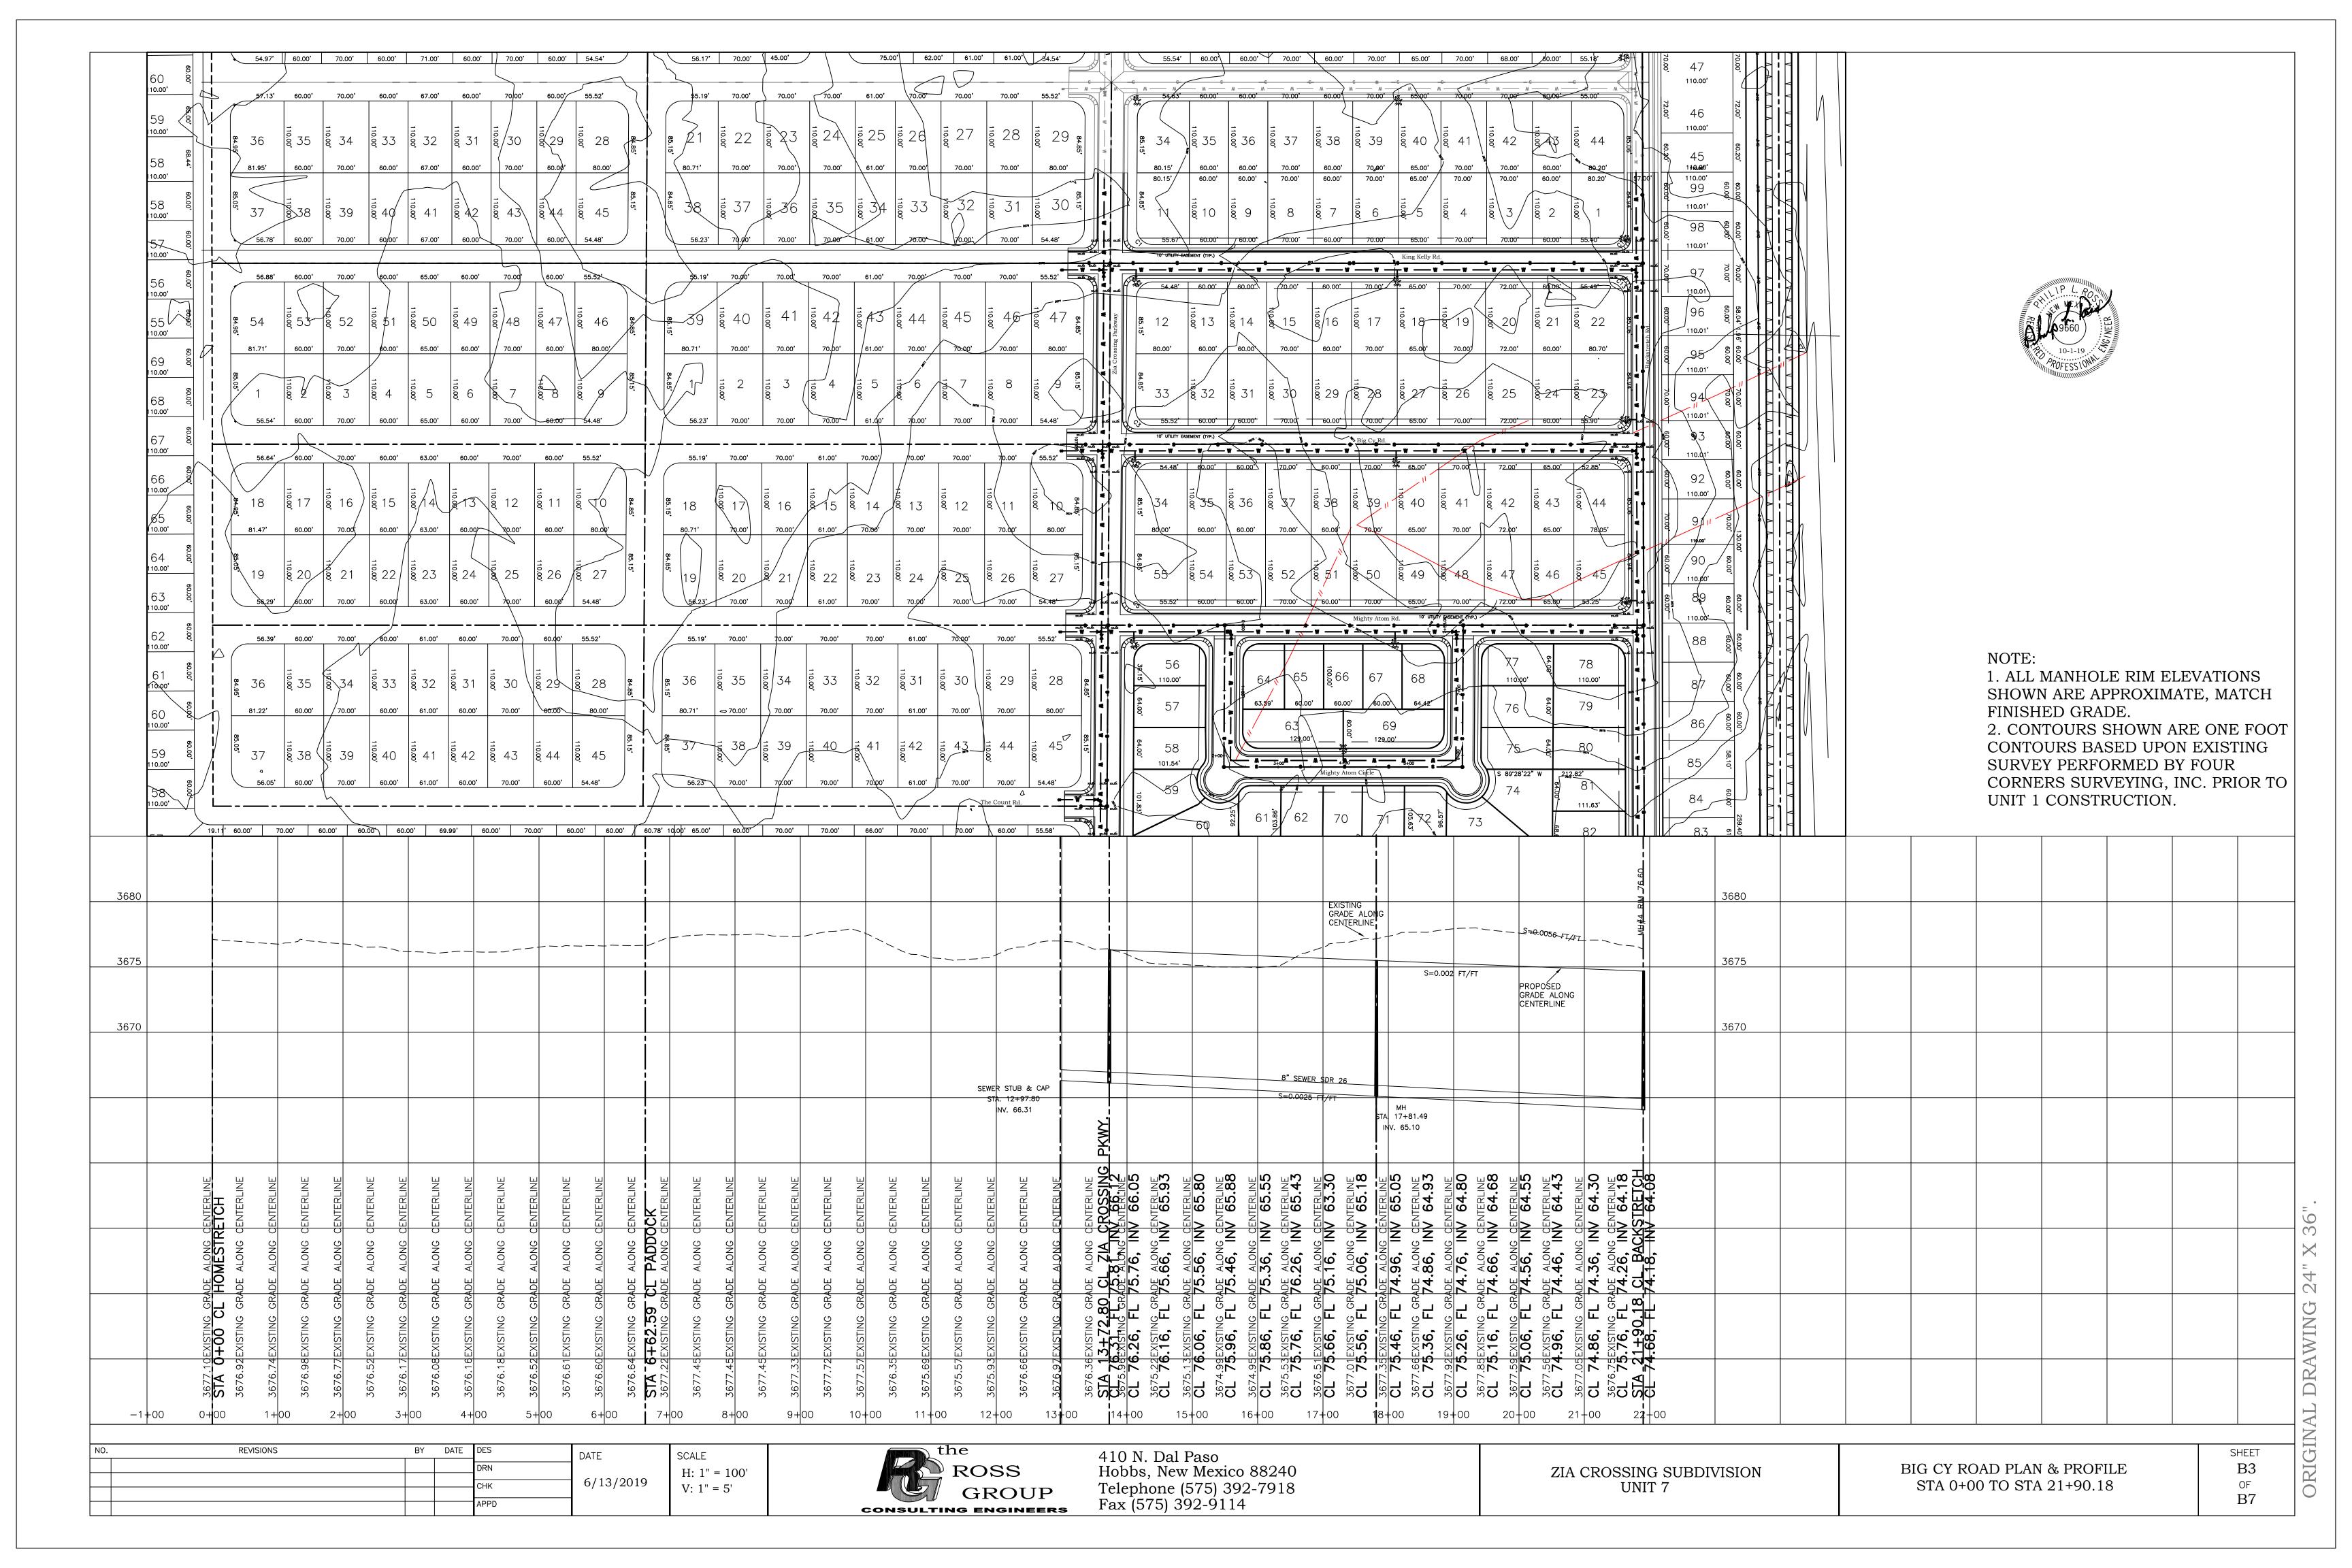


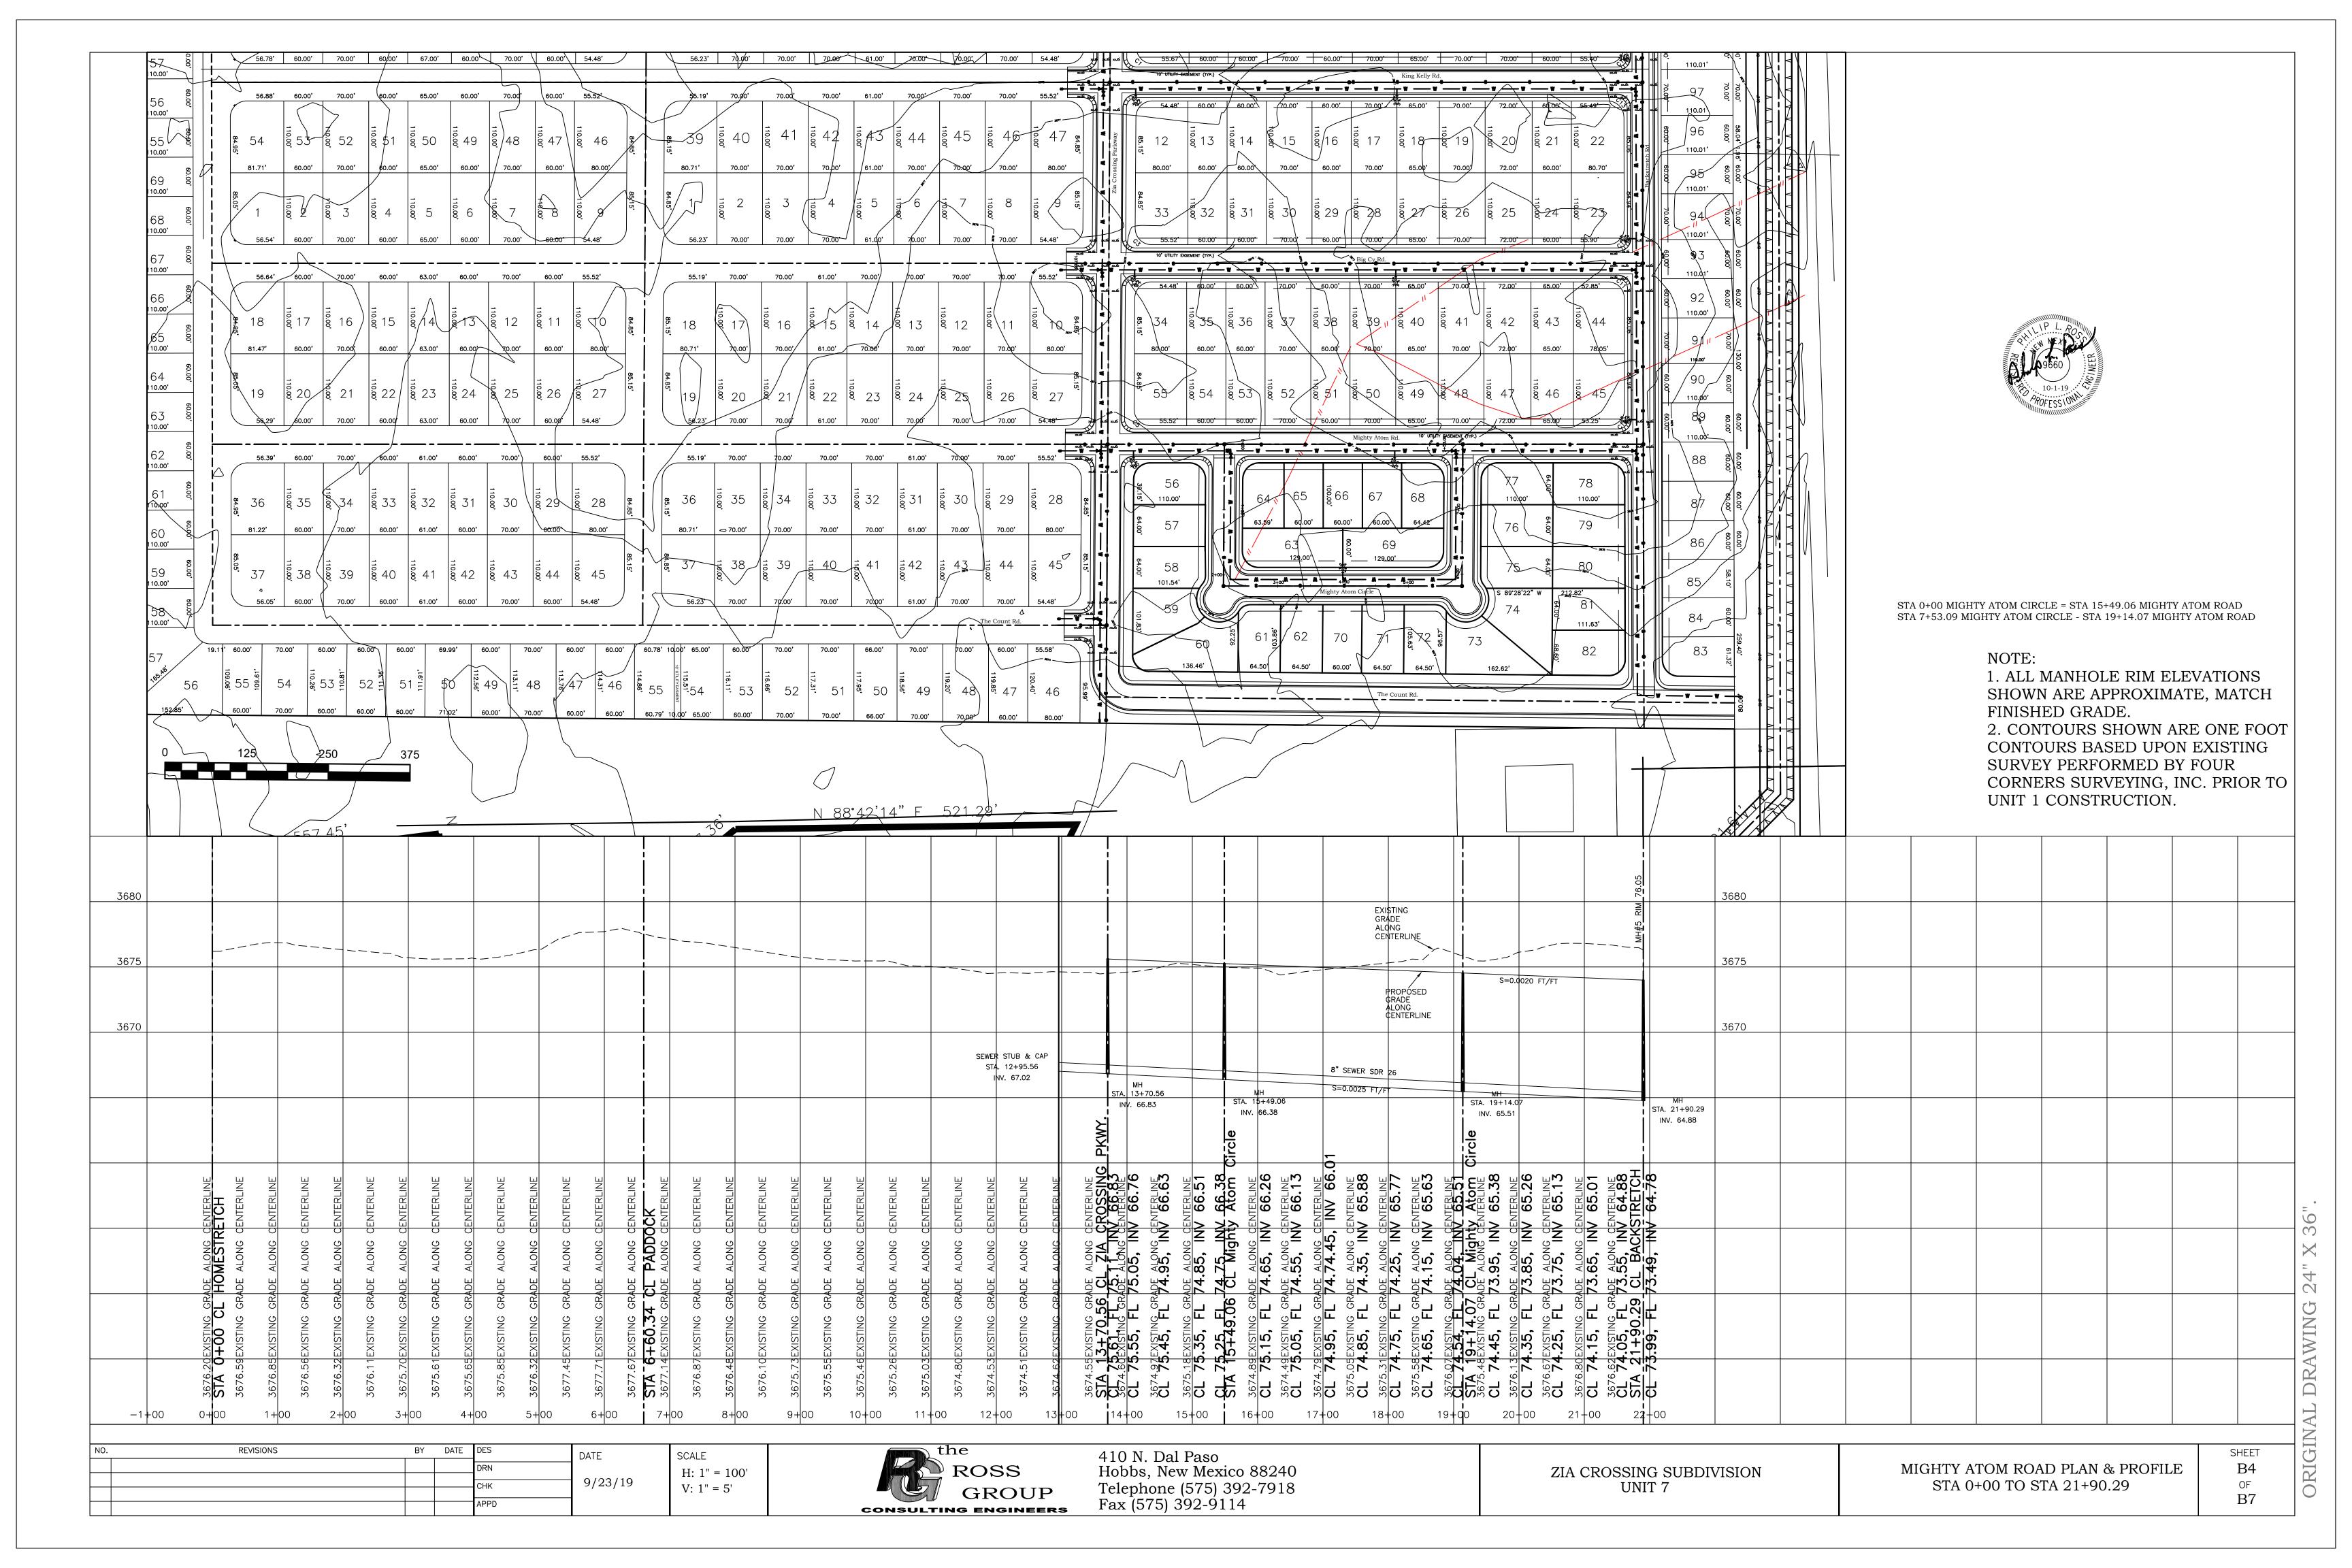


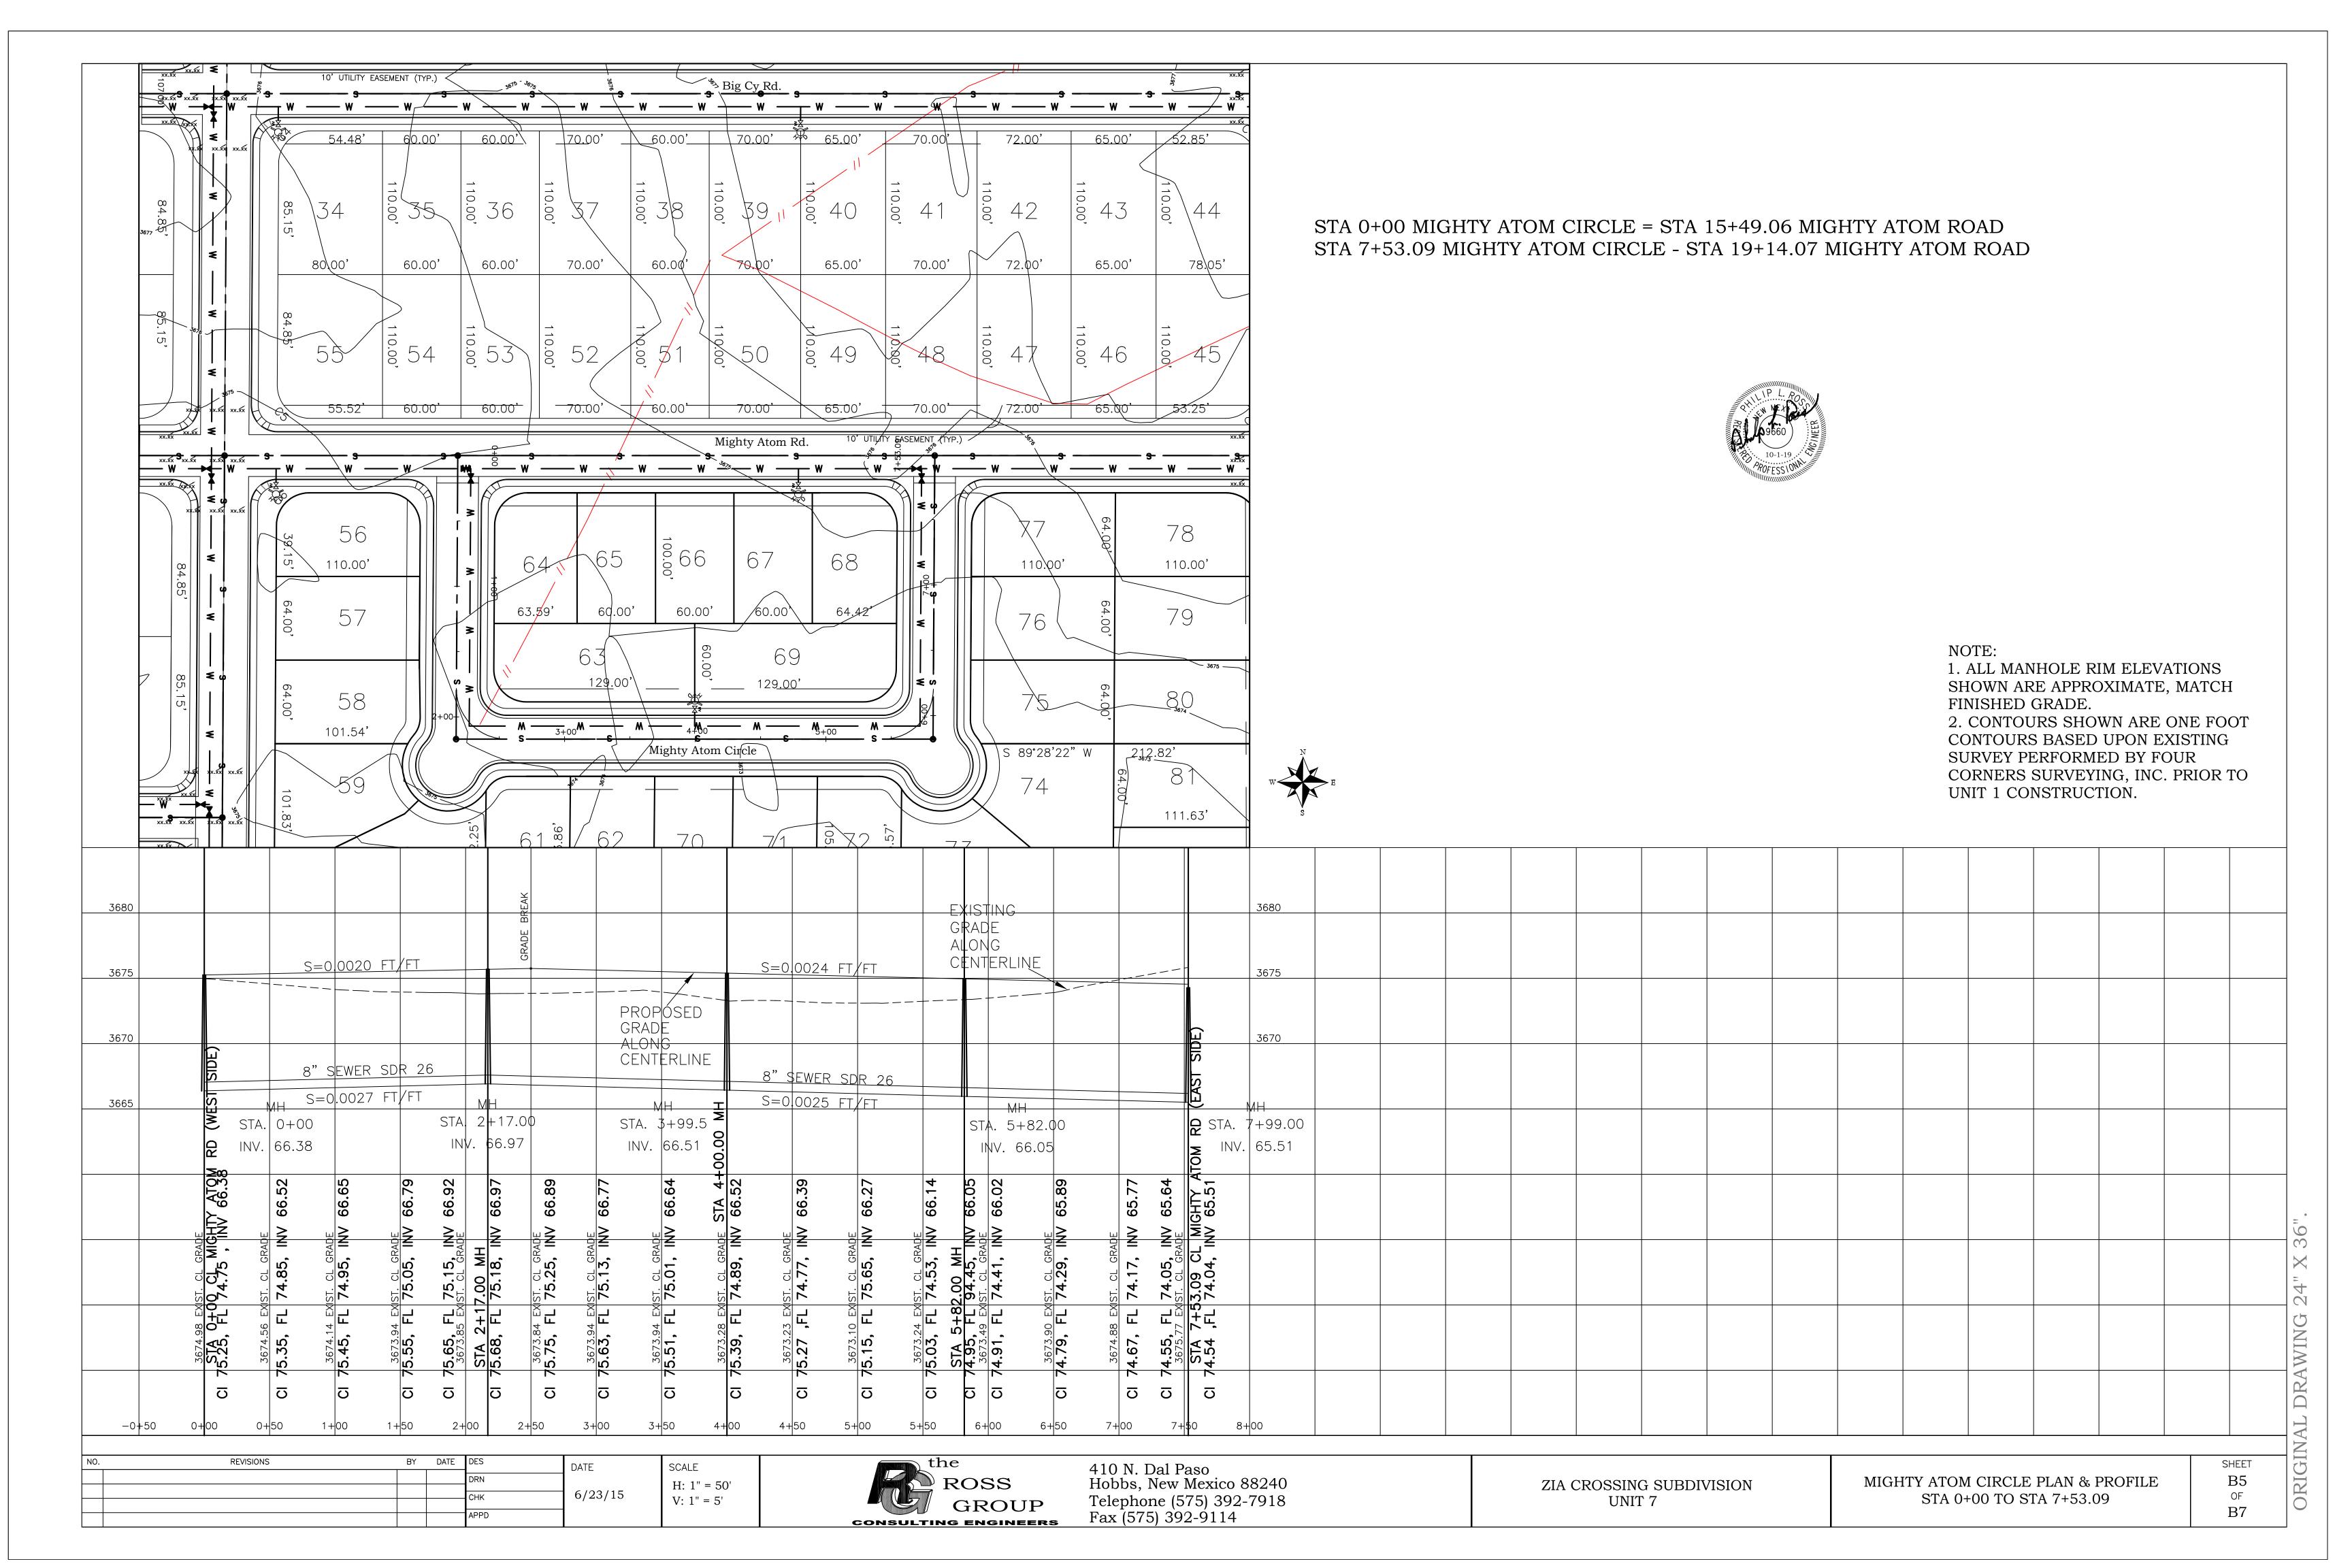


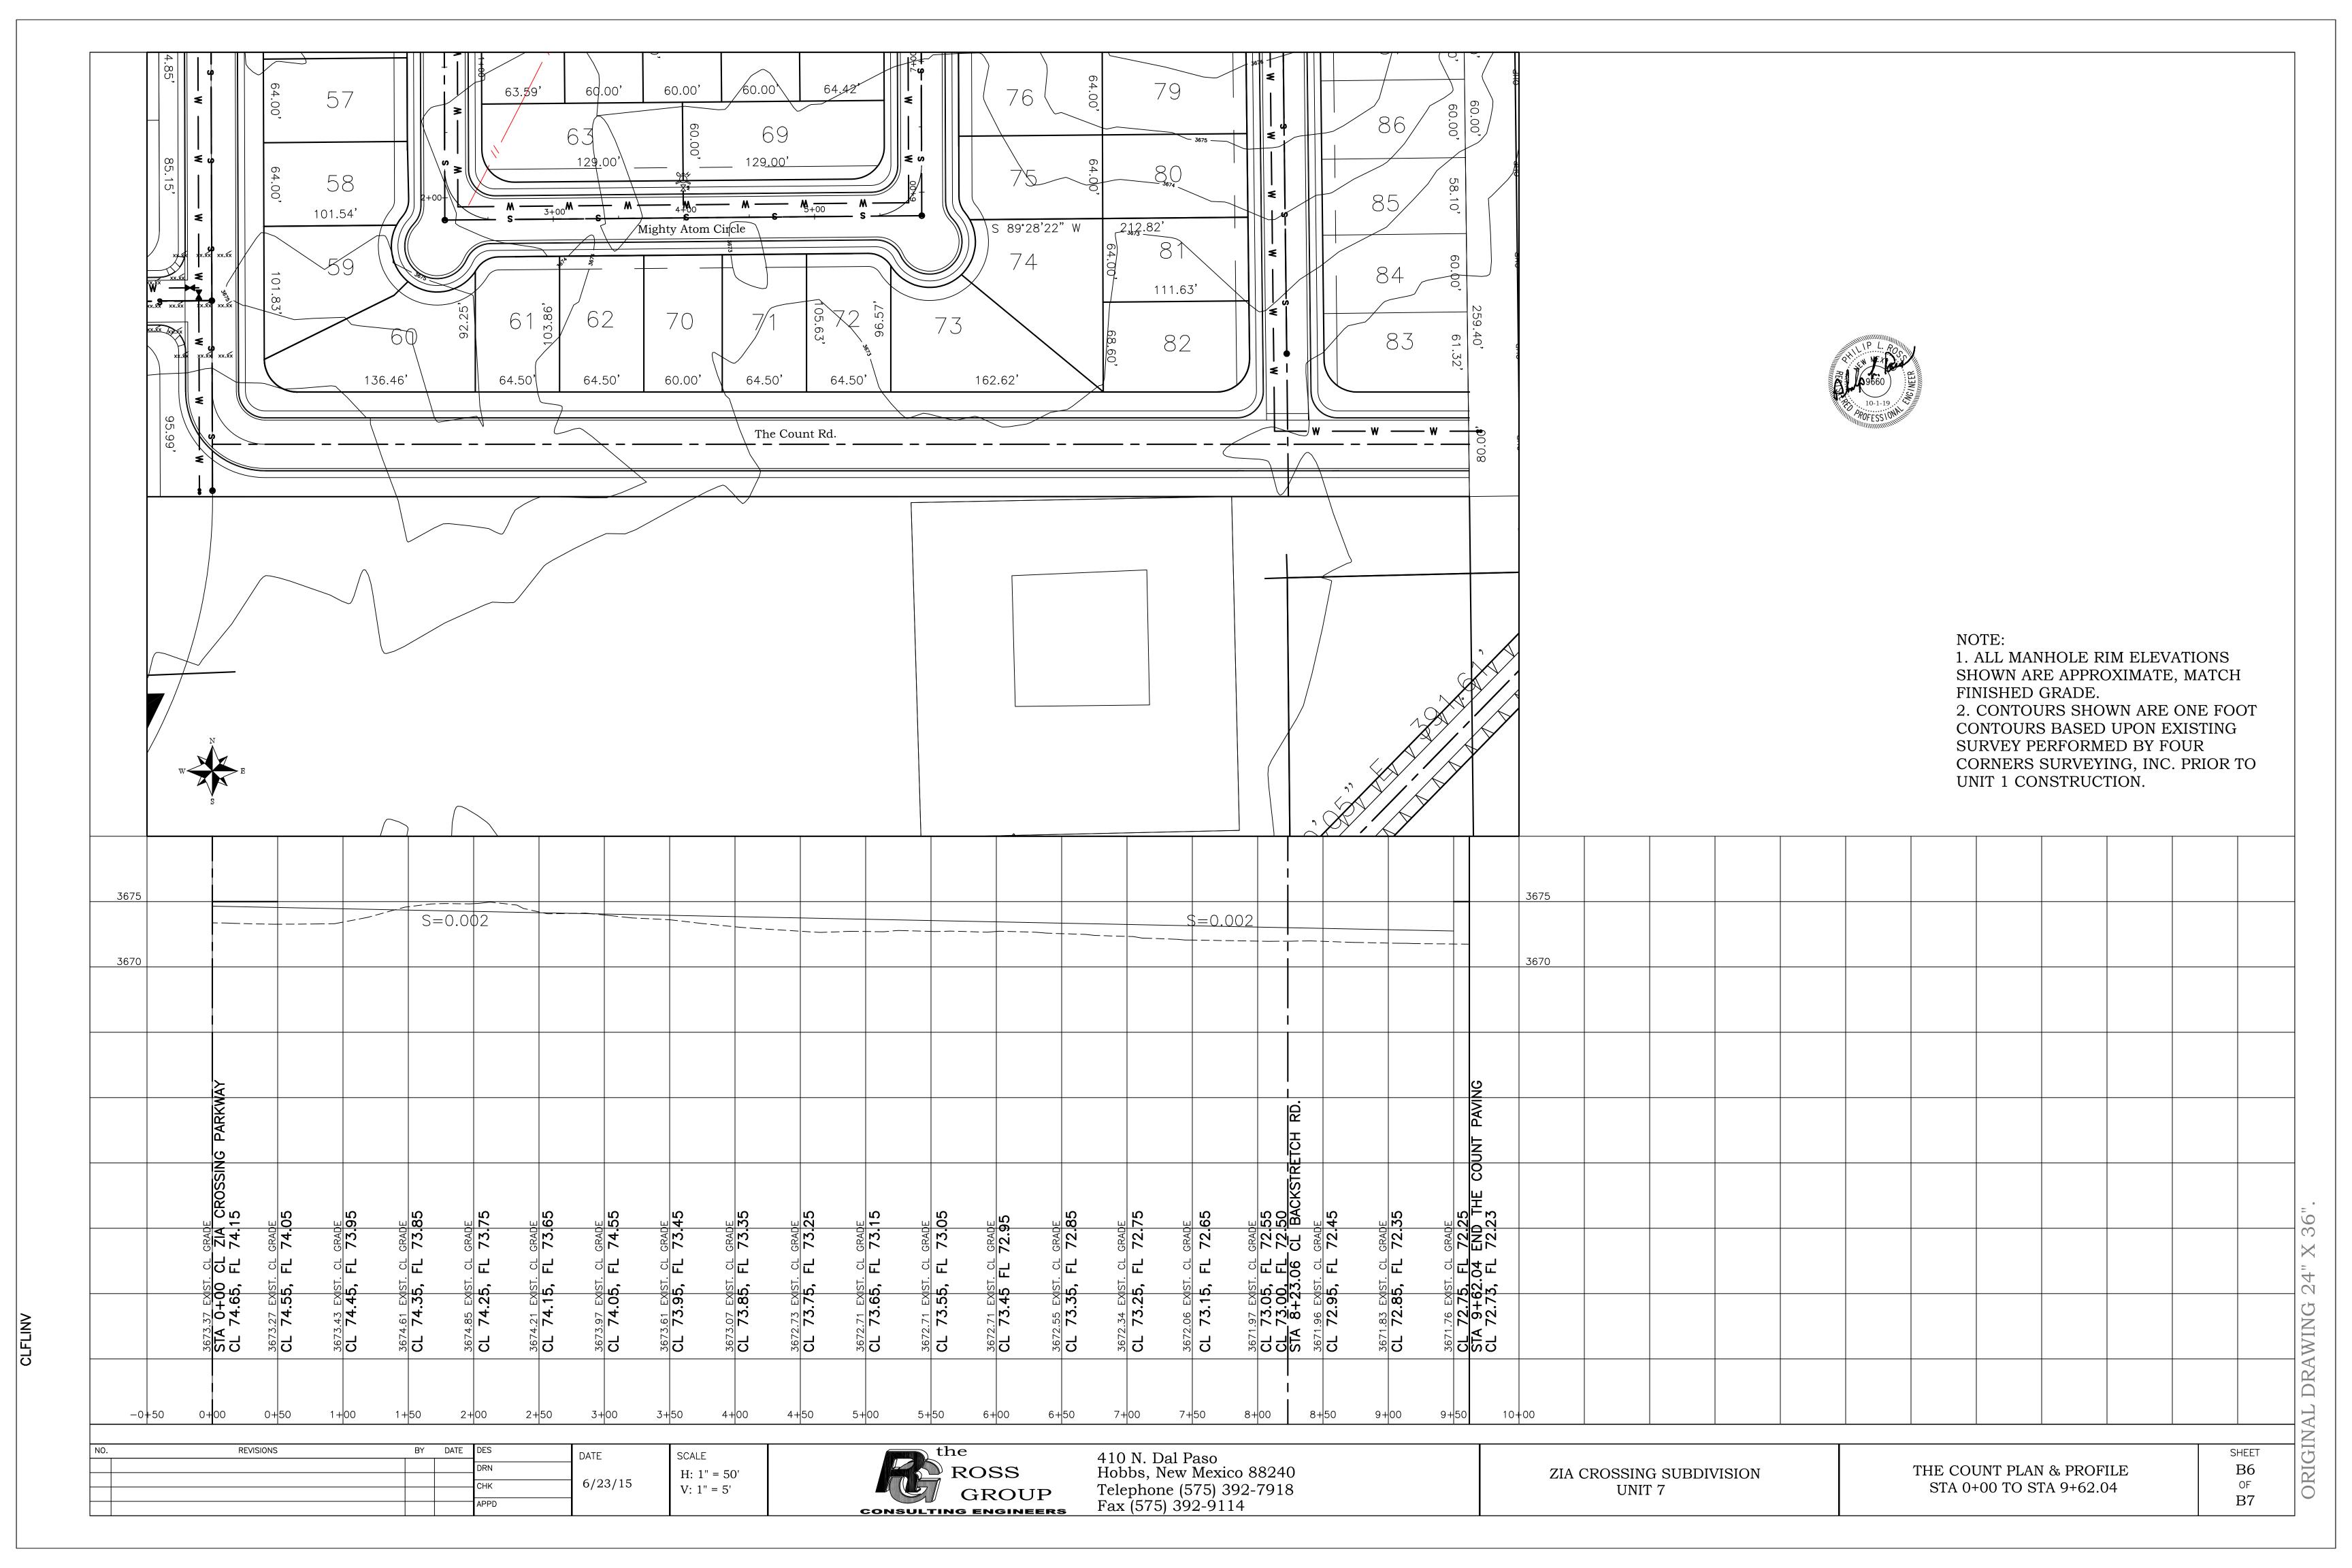

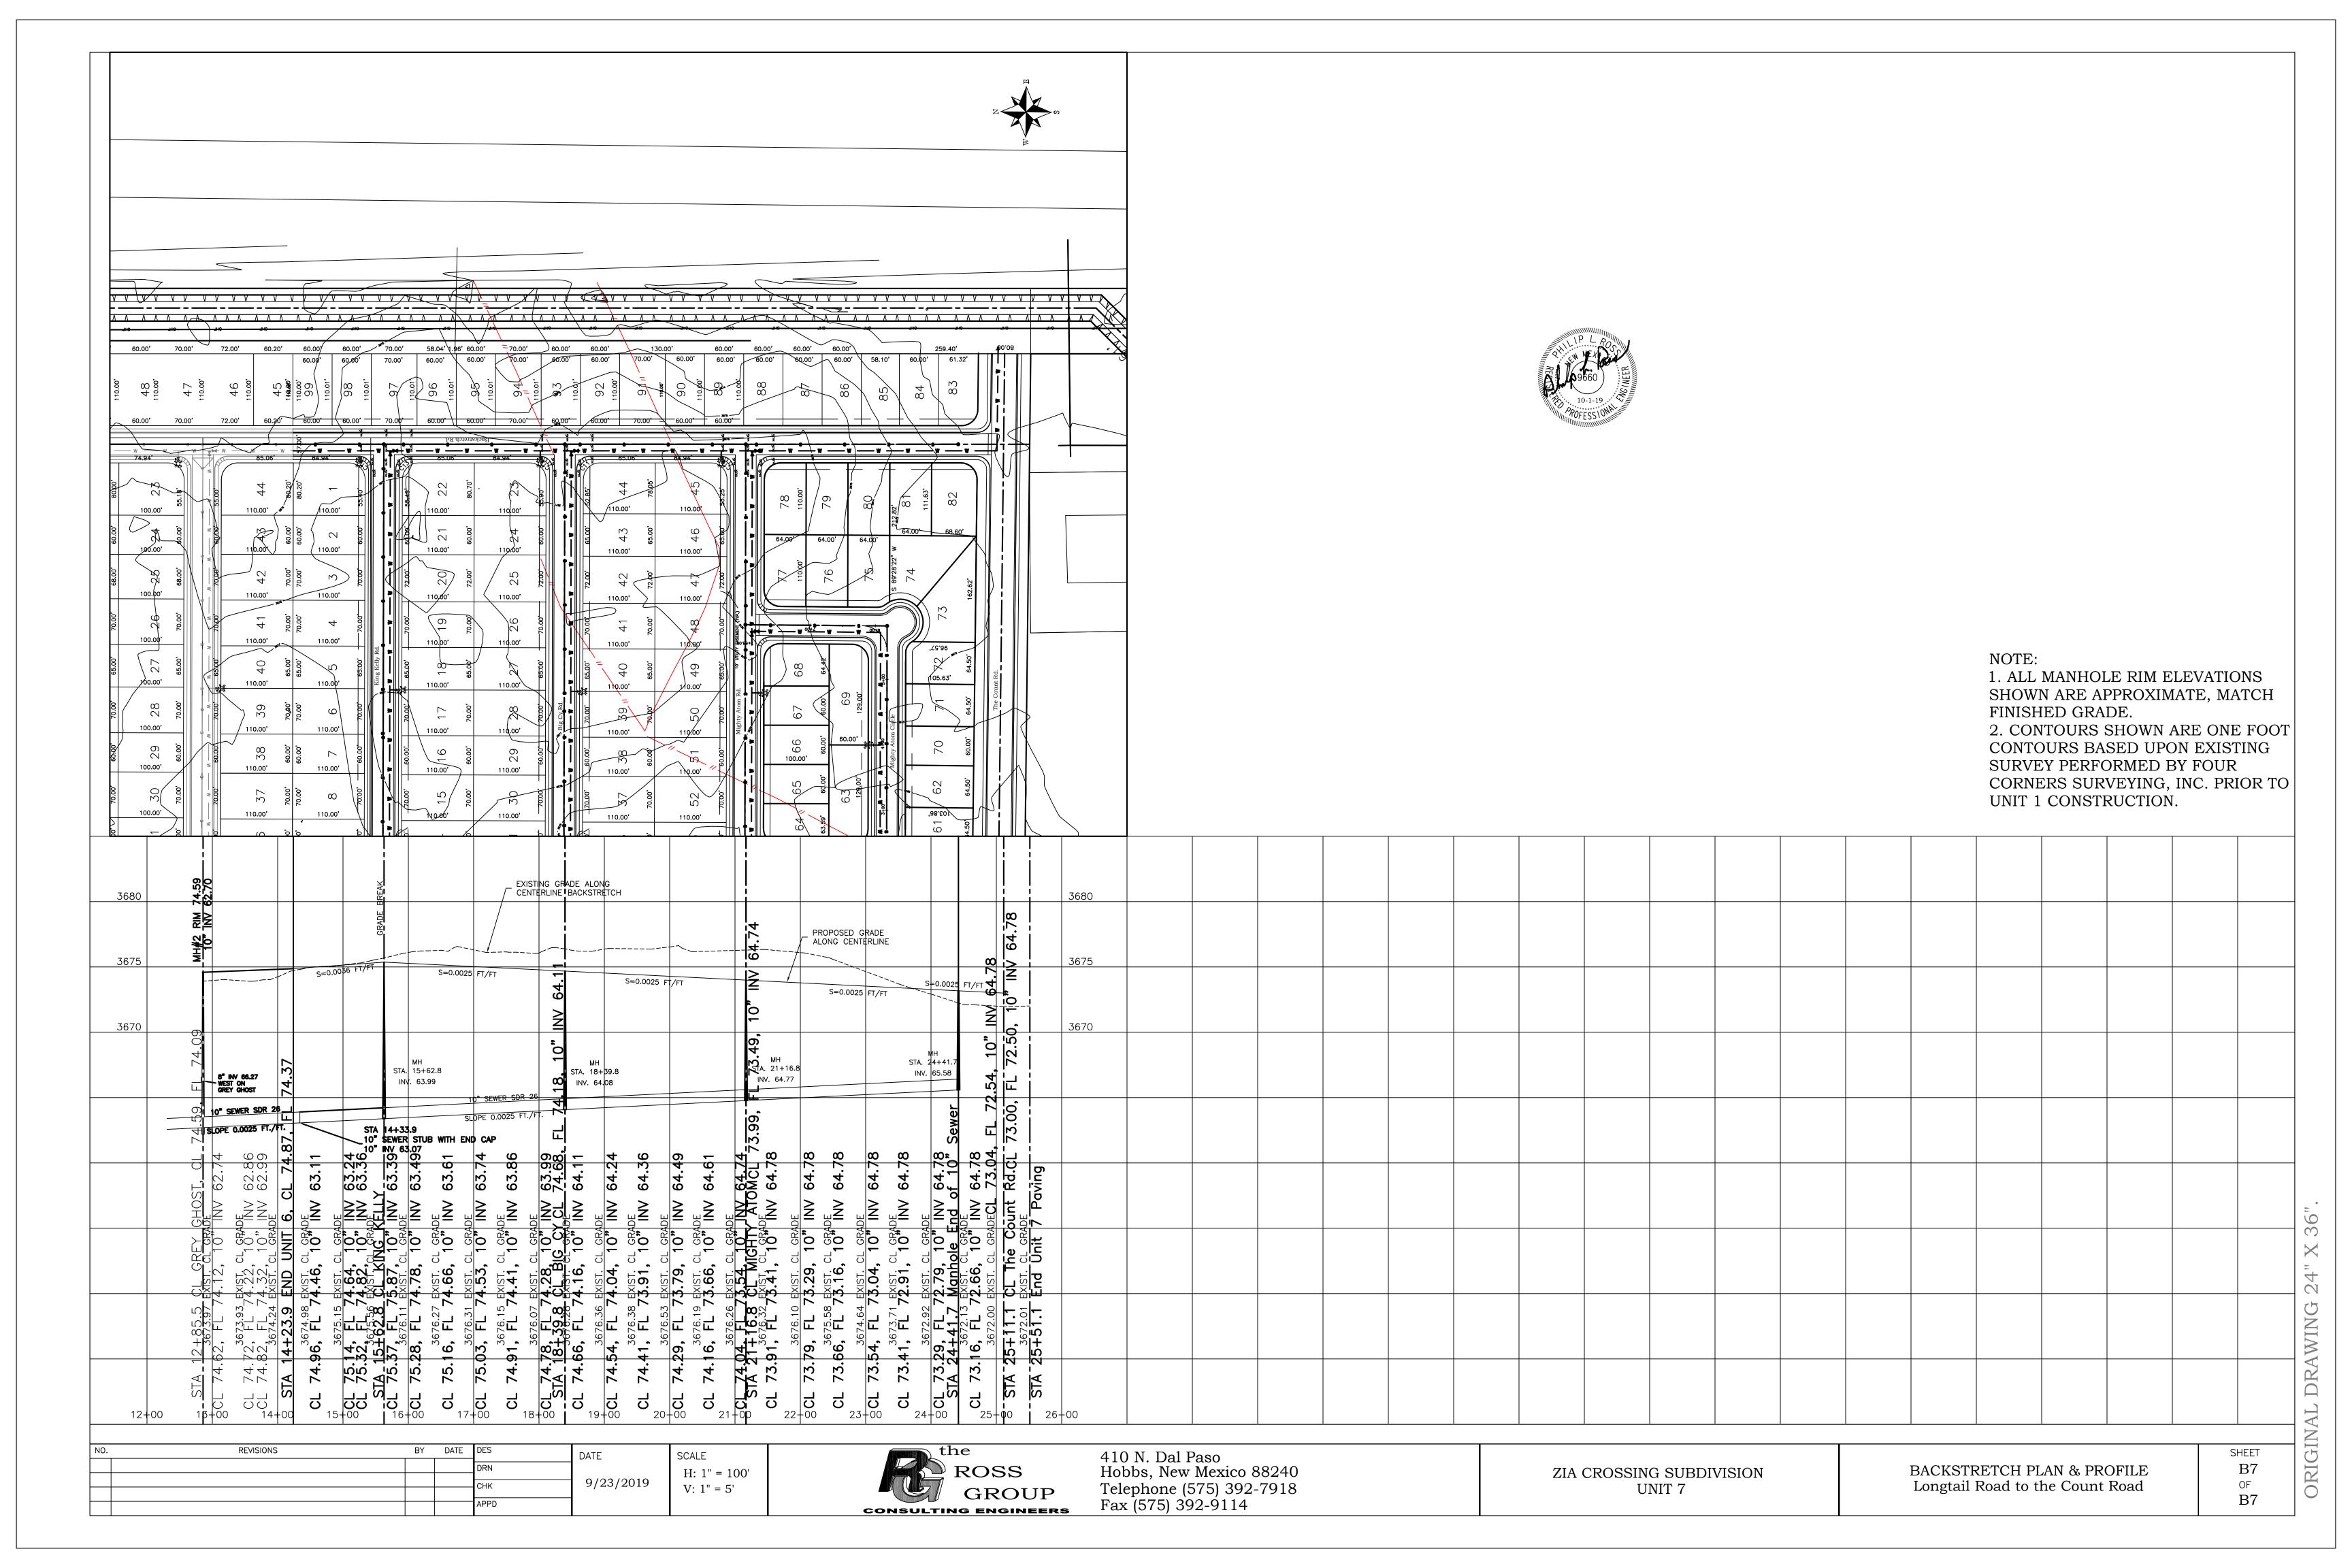

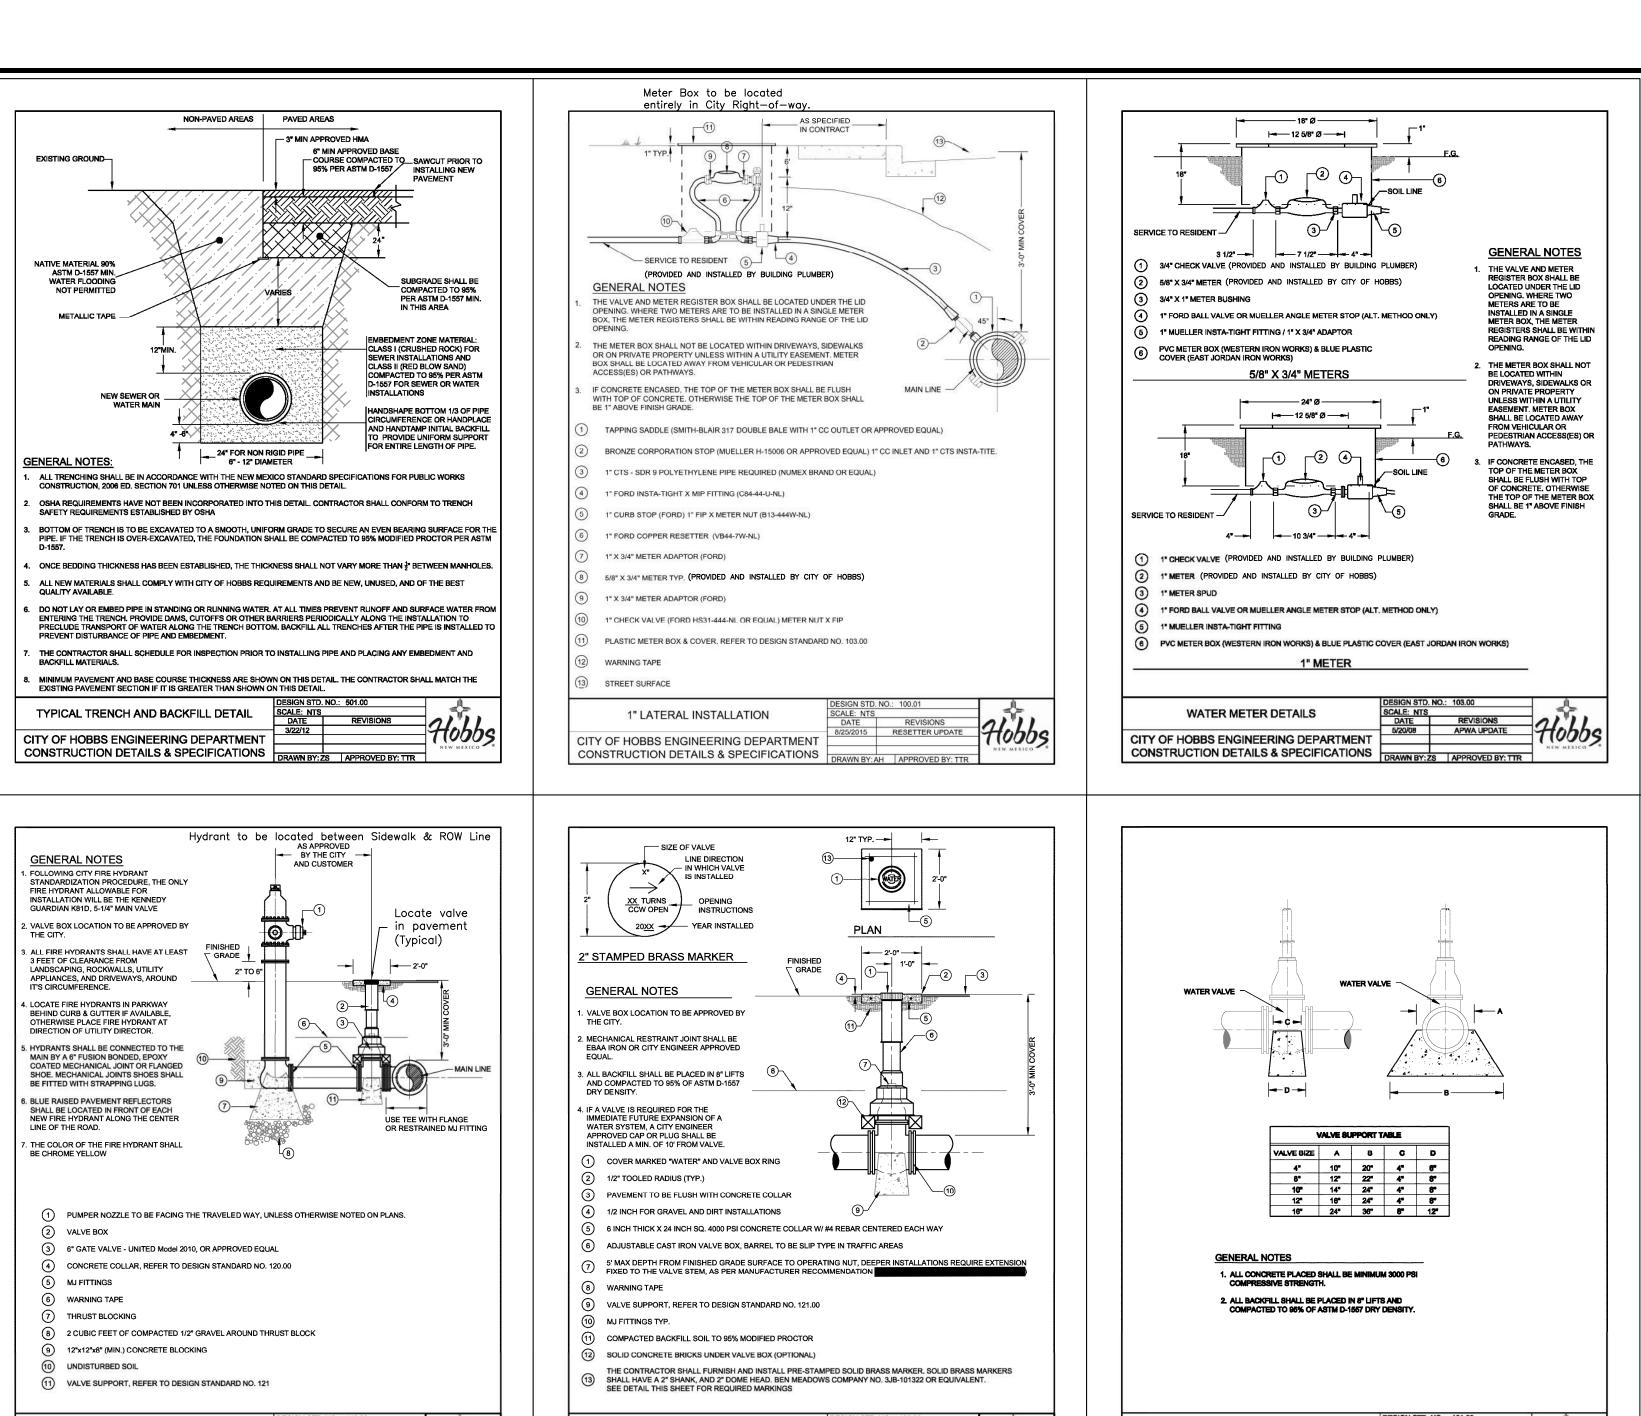

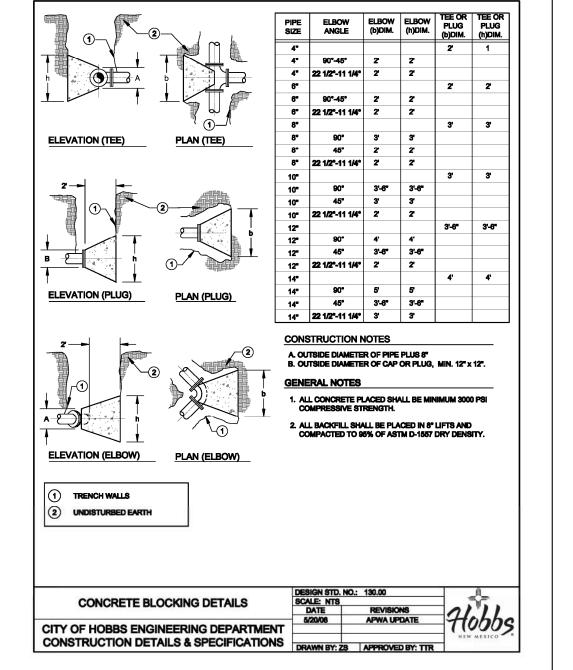


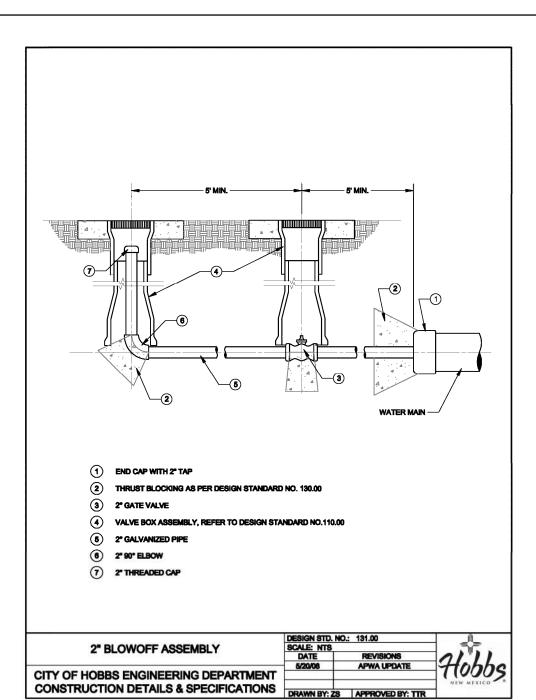

FIRE HYDRANT ASSEMBLY - KENNEDY GUARDIAN-K81D

CONSTRUCTION DETAILS & SPECIFICATIONS

CITY OF HOBBS ENGINEERING DEPARTMENT

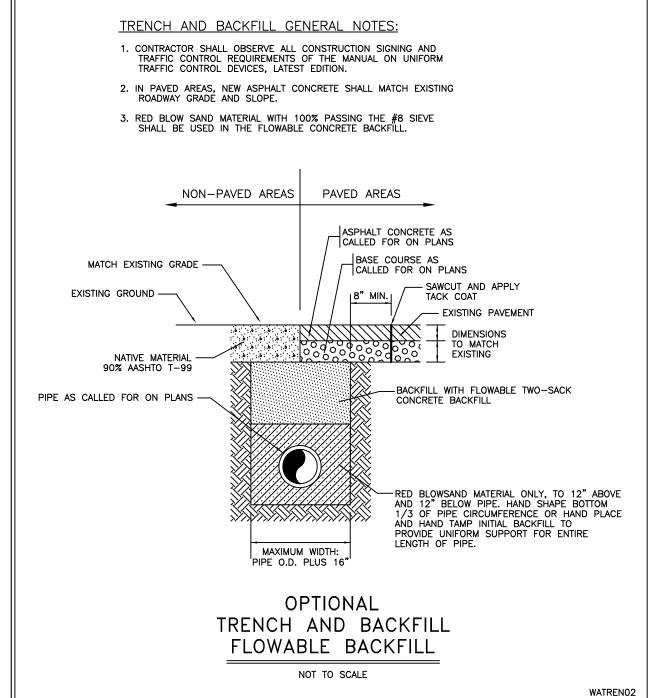

CONCRETE VALVE SUPPORT DETAIL

CITY OF HOBBS ENGINEERING DEPARTMENT

CONSTRUCTION DETAILS & SPECIFICATIONS

TYPICAL WATER VALVE DETAIL -

CITY OF HOBBS ENGINEERING DEPARTMENT

CONSTRUCTION DETAILS & SPECIFICATIONS

(Mueller or Approved Equal)

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24

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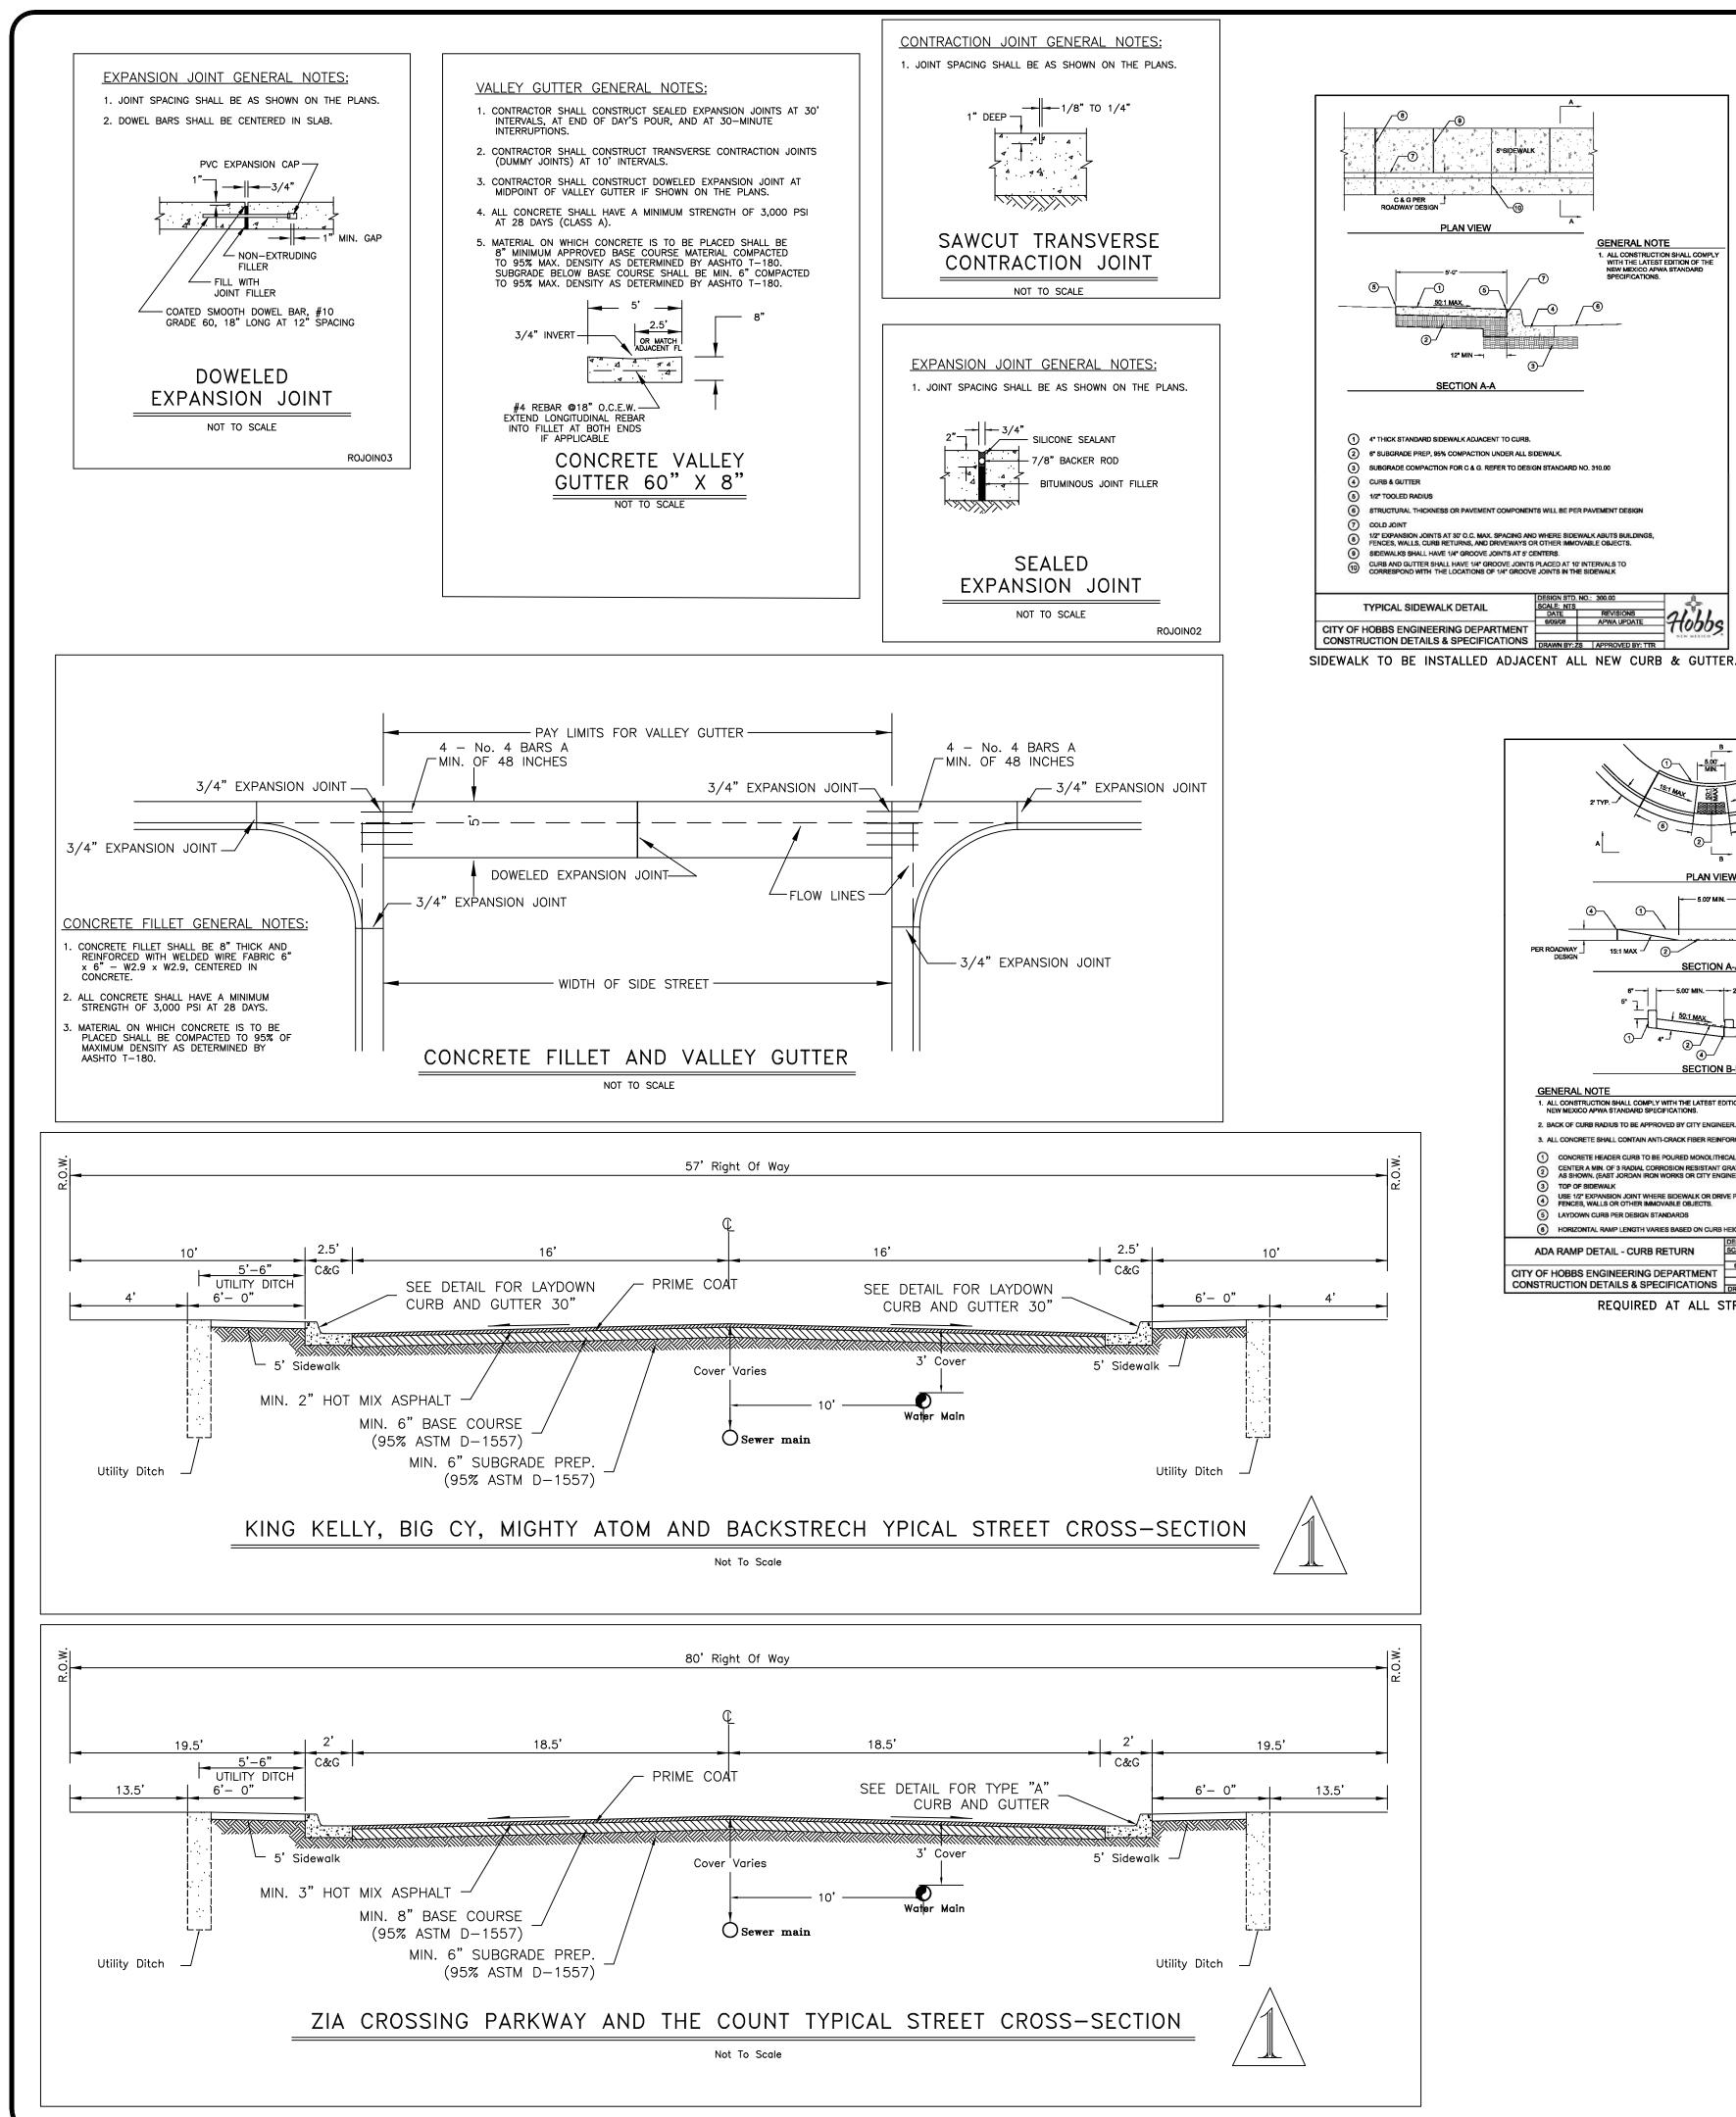
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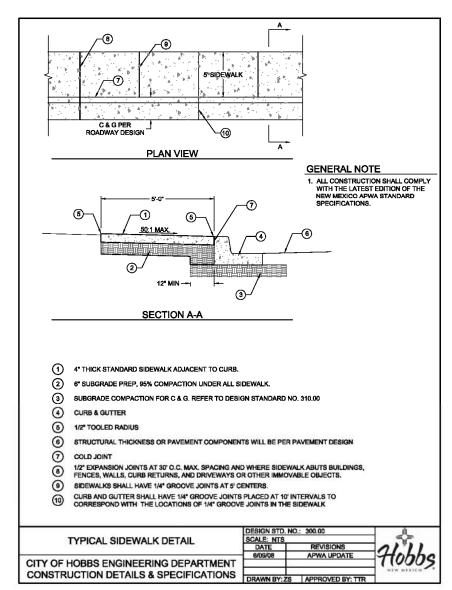
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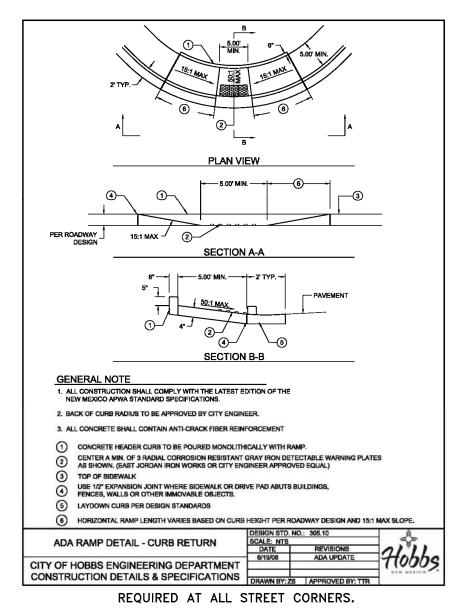
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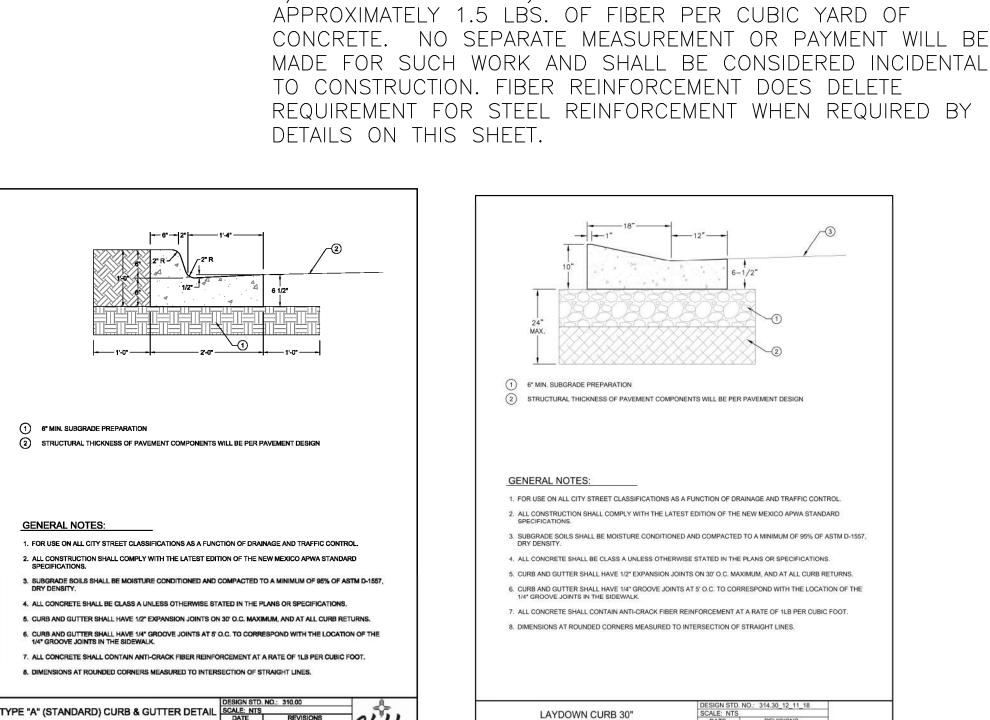
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CITY OF HOBBS ENGINEERING DEPARTMENT

CONSTRUCTION DETAILS & SPECIFICATIONS DRAWN BY: ZS APPROVED BY: TTR

ZIA CROSSING PKWY. & THE COUNT CURB SECTION

ROADWAY CONSTRUCTION GENERAL NOTES:

ALL CONCRETE WORK SHALL INCLUDE FIBER REINFORCEMENT.


FIBERS SHALL BE VIRGIN POLYPROPYLENE STRANDS (APPROX.

3/4 inches IN LENGTH). ALL CONCRETE SHALL CONTAIN

ITY OF HOBBS ENGINEERING DEPARTMENT

CONSTRUCTION DETAILS & SPECIFICATIONS

KING KELLY, BIG CY, MIGHTY ATOM & BACKSTRECH CURB SECTION

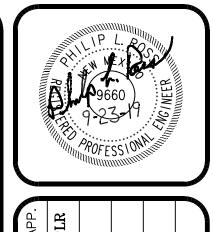


CURB AND GUTTER

CURB END TREATMENT

NOT TO SCALE

ġ	DATE	REVISIONS:	B	CHK	CHK ENGR APP.	Ą
	9/23/19	9/23/19 REVISED PLAT/REV. ROADWAY SECTIONS	SMM	PLR	SMM PLR PLR PLR	PL
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4000 PSI CONCRETE BASE TO BE POURED IN PLACE USING #5 REBAR AT 8" O.C. EACH WAY. FOR MANHOLE DEPTH, FROM RIM TO INVERT, OF UP TO 16' AND MAXIMUM PIPE DIAMETER OF 24".

COMPACT BACKFILL UNDER ALL MANHOLES TO 95% MODIFIED PROCTOR DENSITY.

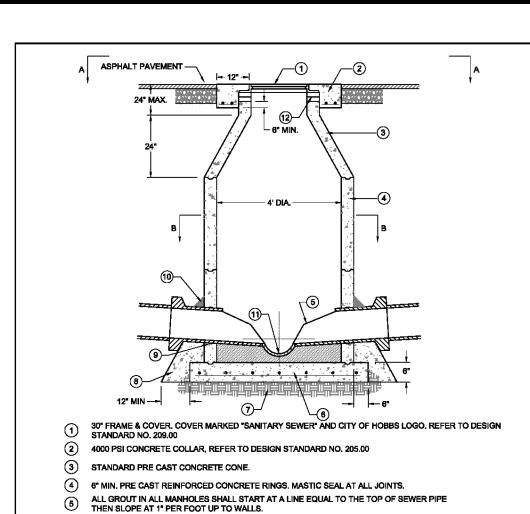CONCRETE PIPE SUPPORTS SHALL EXTEND OUTSIDE OF M.H. TO BELL OF FIRST JOINT AND SHALL CRADLE PIPE TO SPRING LINE.


APPROVED WATERSTOP TO BE COMPATIBLE WITH TYPE OF PIPE. (10) 6" GROUT FILLET ON UPPER HALF OF PIPE AND AROUND BASE.


(11) INVERT ELEVATION OF STUB OR LATERAL AS SHOWN ON PLANS.


USE PRECAST ADJUSTMENT RINGS OR MAX. 4 COURSES GR. MS BRICK FOR FUTURE ADJUSTMENT OF MANHOLE FRAME TO PAVEMENT GRADE. GROUT INSIDE WITH 1/2\* MORTAR.


(13) REFER TO DESIGN STANDARD DRAWING NO. 212.00 FOR CROSS SECTIONS A-A AND B-B


ALTERNATE PRECAST TYPE "C" MANHOLE SCALE: NTS CITY OF HOBBS ENGINEERING DEPARTMENT

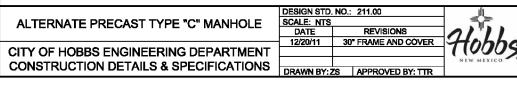


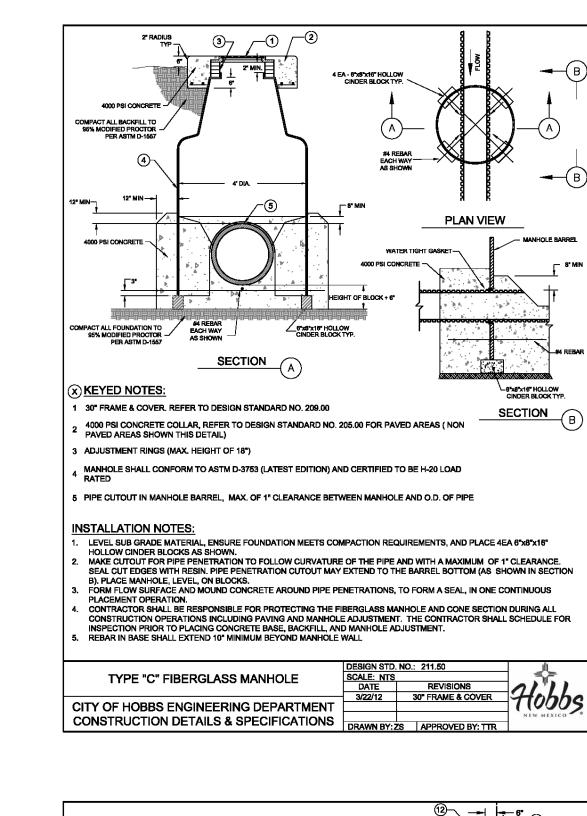

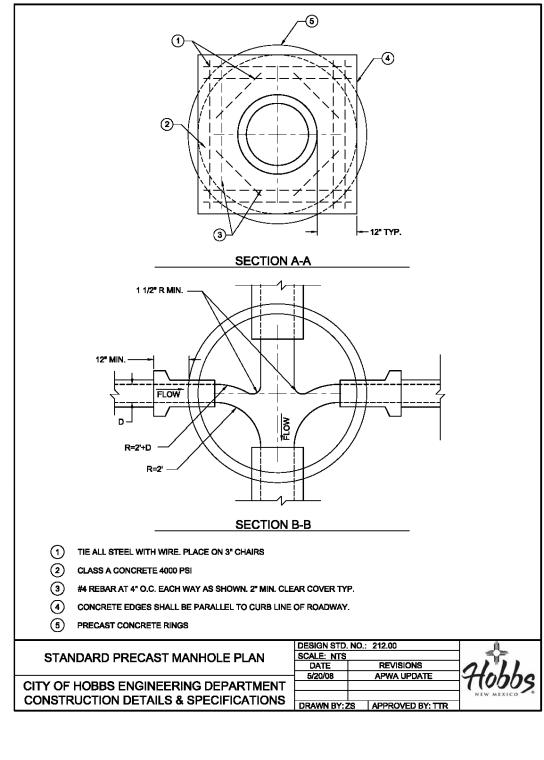

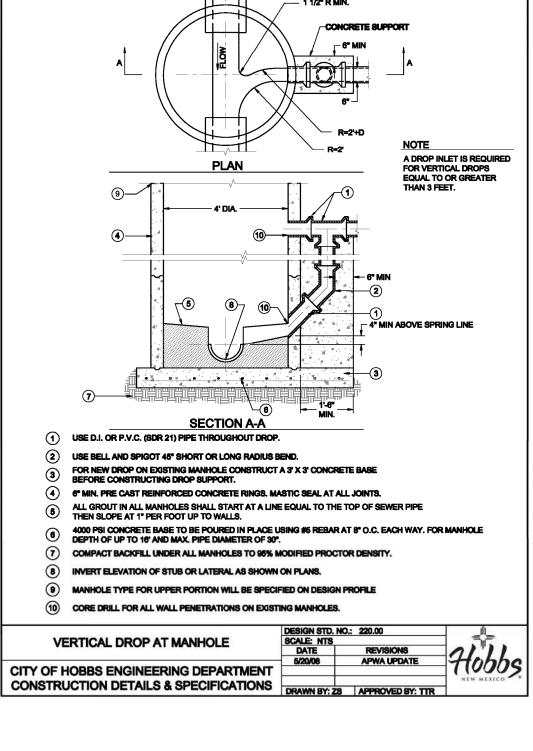

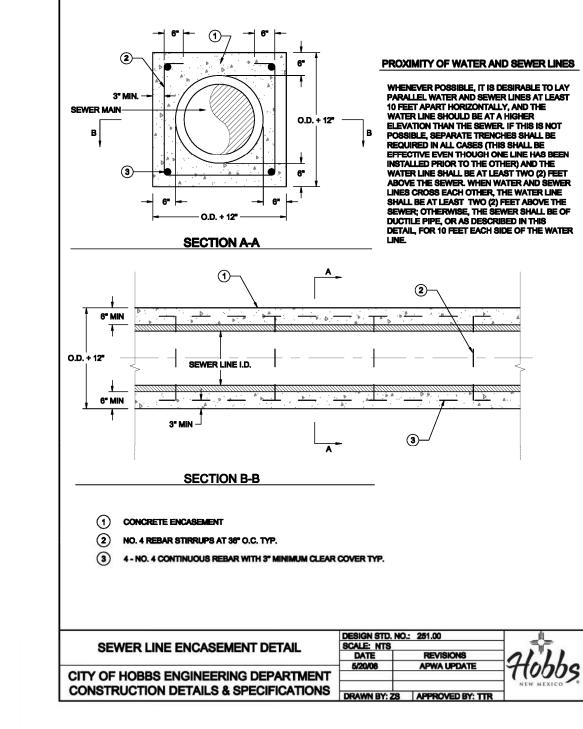

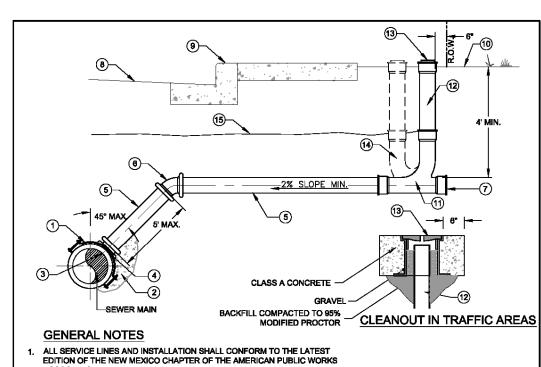

CONCRETE ENCASED TRAFFIC RATED SEWER CLEANOUT FRAME AND COVER ASSEMBLY (LBIW LB 1240/X-510A OR APPROVED EQUAL). PVC CAP IN NON TRAFFIC AREAS

SERVICE LINE SHALL NOT PROTRUDE INTO SEWER MAIN.

(14) OPTIONAL DOUBLE WYE ASSEMBLY (4" PVC RISER & PVC CLEAN OUT)

SEWER LATERAL DETAIL

CITY OF HOBBS ENGINEERING DEPARTMENT

CONSTRUCTION DETAILS & SPECIFICATIONS

(6) 22.5° OR 45° BEND

(8) STREET SURFACE


(10) FINISHED GRADE

(12) 4" PVC RISER

(15) WARNING TAPE

(11) WYE

7 PLUG OR CAP

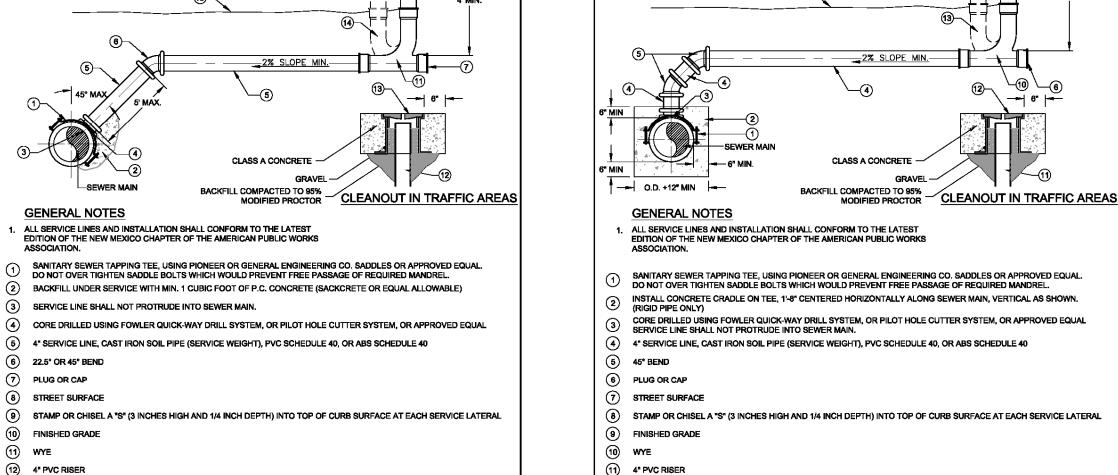

13) OPTIONAL DOUBLE WYE ASSEMBLY (4" PVC RISER & PVC CLEAN OUT)


ALTERNATE SEWER LATERAL DETAIL


CITY OF HOBBS ENGINEERING DEPARTMENT


CONSTRUCTION DETAILS & SPECIFICATIONS

(14) WARNING TAPE

CONCRETE ENCASED TRAFFIC RATED SEWER CLEANOUT FRAME AND COVER ASSEMBLY (LBIW LB 1240/X-510A OR APPROVED EQUAL). PVC CAP IN NON TRAFFIC AREAS

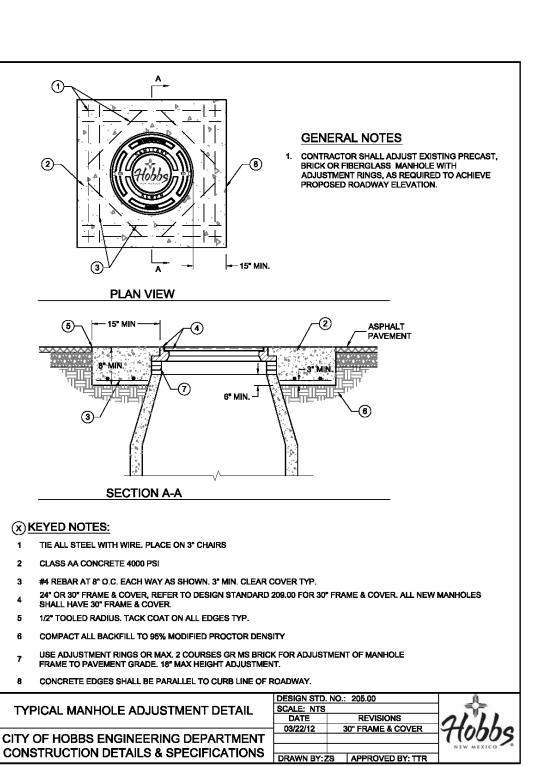

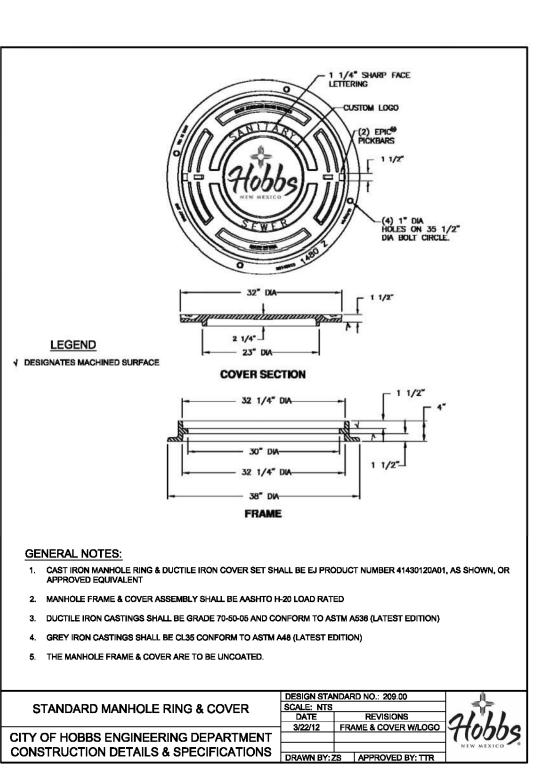

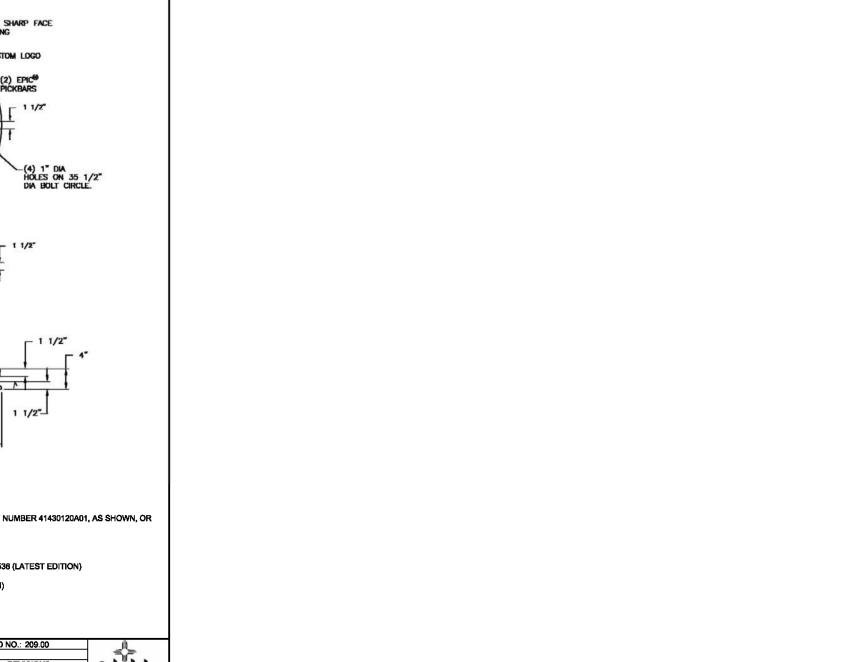


NOTE:

SEE WATER DETAILS (SHEET W1) FOR TRENCH DETAILS, BOTH MECHANICAL

COMPACTION AND/OR FLOWABLE FILL




36

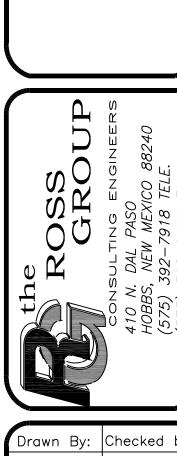



SEWER

SHEET

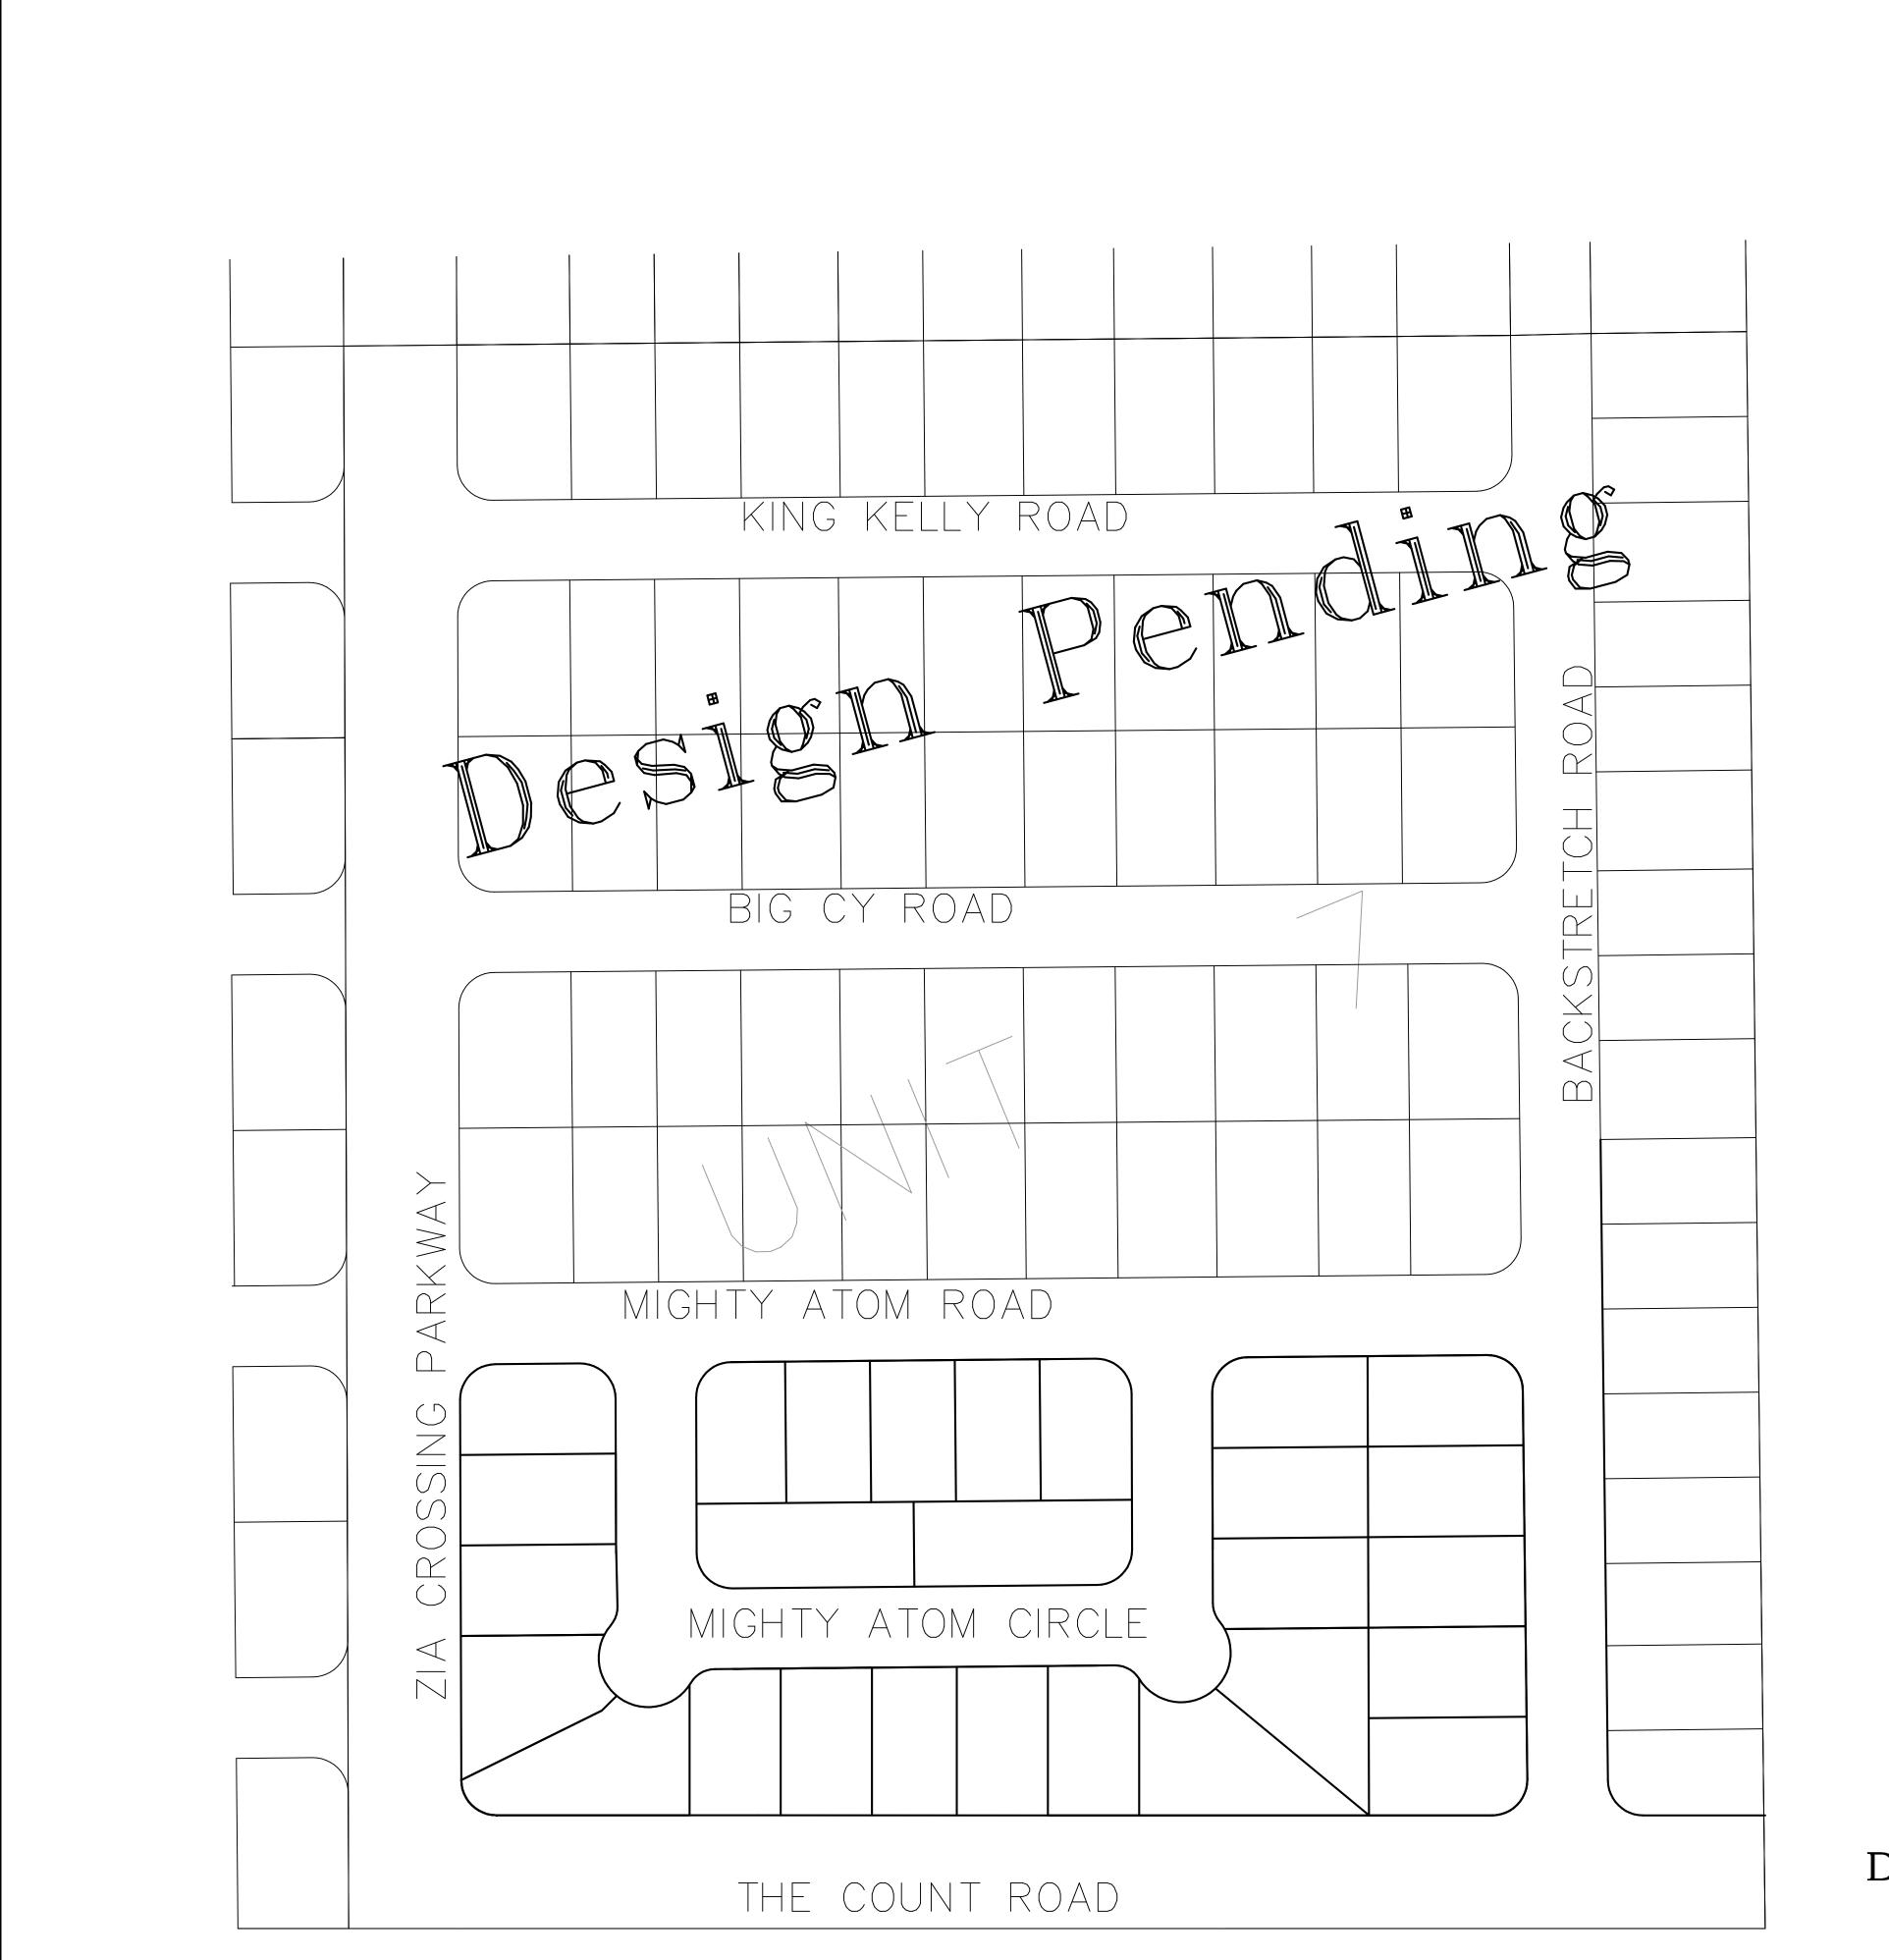

VG UNIT 7

ABLE/TELEPHONE)

XCEL ENERGY)

AG UNIT 7

ABLE/TELEPHONE

- NOT FOR CONSTRUCTION

PRELIMINARY

TIA CROSSING UNIT 7


THE CTRIC/CABLE/TELE

LAYOUT PLAN (BY XCEL ENEF

the Checked by:

SMM PASO
HOBBS, NEW MEXICO 8
(575) 392-7918 TELE
(575) 392-9114 FAX

DRAWING PROVIDED BY XCEL ENERGY.

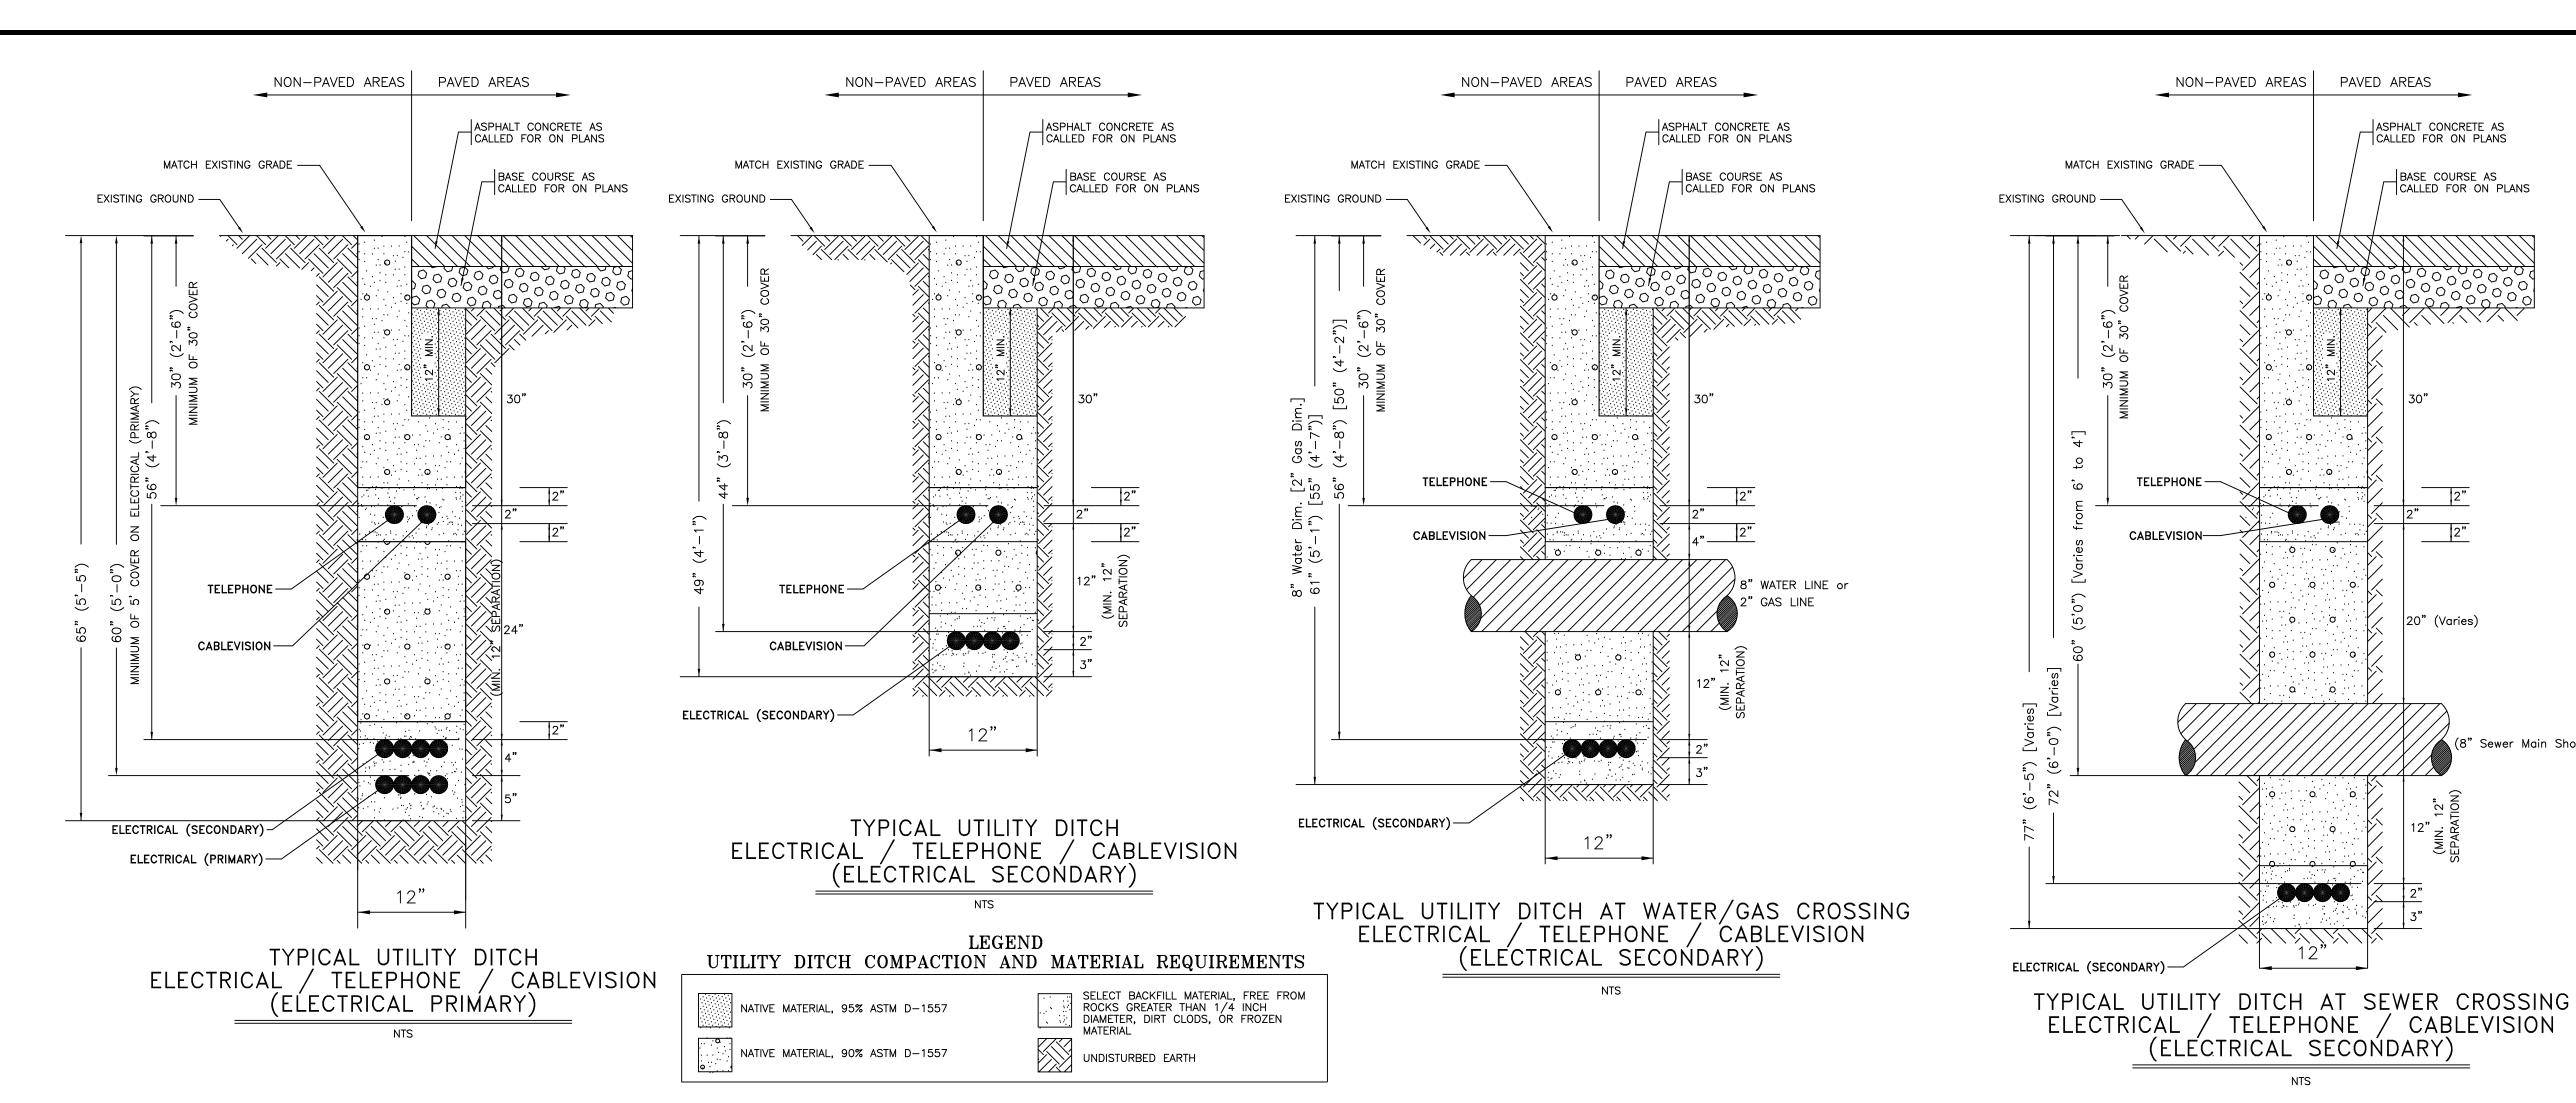

### CONSTRUCTION NOTES: DITCHING (UTILITY) CONTRACTOR

- 1. DITCHES, BACKFILL MATERIALS, BACKFILL & COMPACTION PROVIDED BY DITCHING CONTRACTOR.
- 2. DITCHING CONTRACTOR SHALL BE RESPONSIBLE FOR COORDINATING WITH ALL UTILITY OWNERS AND FOR THE PROTECTION OF ALL FACILITIES AFTER THEIR INSTALLATION. IF APPLICABLE, GAS COMPANY SHALL DITCH, INSTALL, BACKFILL AND COMPACT THEIR OWN UTILITIES.
- 3. ANY UTILITIES DAMAGED BY THE DITCHING CONTRACTOR DURING TRENCHING, COMPACTION, OR INSTALLING SERVICE LATERALS SHALL BE REPAIRED AND/OR REPLACED AT THE EXPENSE OF THE DITCHING CONTRACTOR.
- 4. EXTRA DEPTH NECESSARY FOR THE ELECTRICAL PRIMARY AND SECONDARY TO CROSS UNDER WATER OF SEWER LINES AS SHOWN IN THE TYPICAL DETAILS IS CONSIDERED INCIDENTAL AND NO EXTRA PAYMENT WILL BE MADE.


MIGHTY ATOM CIRCLE THE COUNT ROAD

LEGEND 16 UNIT CBU (TOTAL 7)

CLUSTER BOX UNITS (CBU'S) GENERAL NOTES:

CBU'S AVAILABLE AT WWW.MAILBOXES.COM.

16 UNIT CBU TO BE MODEL NUMBER 3316, WITH PEDESTAL 3385. MANUFACTURED BY SALSBURY INDUSTRIES - ALL ALUMINUM CONSTRUCTION CONTAINING AN OUTGOING MAIL SLOT AND 2 PARCEL LOCKERS EACH. ALL CBU KEYS TO BE DELIVERED TO THE ENGINEER FOR DELIVERY TO THE POST OFFICE.

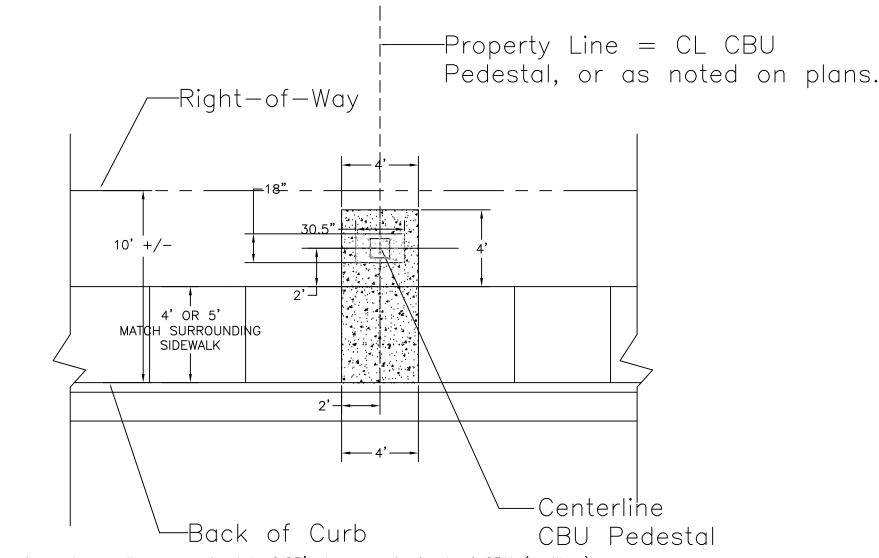

1. Dimensions shown allow approximately 6.25' clearance in front of CBU (mailbox)

- 2. See manufacturer's installation guide for installation of CBU pedestal and box. 3. Centerline of CBU Pedestal shall not be located closer than 25' from curb return at corner lots.
- 4. If CBU placed in area with out curb and gutter, 4' x 4' sidewalk still required in front of slab for pedestal.

TYPICAL CLUSTER BOX UNIT (CBU) CONCRETE DETAIL

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POST OFFICE UTILITY (ELEC

Drawn By: Checked I 9/23/19 | GENERAL File Name: Job No. ROADS

CLUSTER BOX UNIT (CBU) TYPE AND LOCATION

### October 15, 2019 Planning Board Regular Meeting



### NOTES

- 1. BASIS OF BEARINGS IS NEW MEXICO STATE PLAN EAST ZONE.
- 2. ALL DISTANCES ARE HORIZONTAL GROUND DISTANCES.

### **EXISTING EASEMENTS:**

- 1) 40-FOOT PUBLIC INFRASTRUCTURE EASEMENT FILED SEPTEMBER 08, 2017, BK. 2121, PG. 34.
- (2) 30-FOOT ROADWAY EASEMENT FILED OCTOBER 21, 1998, BK. 912, PGS. 954-966.

### NEW EASEMENTS:

- $\langle 1 \rangle$  15-FOOT PUBLIC INFRASTRUCTURE EASEMENT BY THE FILING OF THIS PLAT.
  - angle 20-FOOT PUBLIC INFRASTRUCTURE EASEMENT BY THE FILING OF THIS PLAT.
  - > 40-FOOT PUBLIC INFRASTRUCTURE EASEMENT BY THE FILING OF THIS PLAT.

### LEGEND



FOUND QUARTER CORNER AS NOTED

FOUND SECTION CORNER AS NOTED

SET 18"x1/2" REBAR WITH BLUE PLASTIC CAP MARKED "F&C PS 22909"

CALCULATED CORNER NOT SET

A tract of land located in Section 4, Township 18 South, Range 38 East, N.M.P.M., Lea County, New Mexico, being and comprising all of Tract 1 of The Meadows Subdivision as the same shown and designated on the plat thereof, filed in the County Clerk of Lea County, New Mexico on February 26, 2019 in Book 2146, Page 503 and being more particularly described as follows:

Beginning at the southeast corner of the tract herein described, identical to the northeast corner of The Meadows Subdivision, Unit I, from which a 2—inch brass cap found for the south quarter corner of said Section 4, bears S00°40′52″E, a distance of 550.57 feet;

Thence, along the north boundary line of The Meadows Subdivision, Unit 1, S89\*20'17"W, a distance of 662.22 feet to the southwest corner of the tract herein described, identical to the northwest corner of The Meadows Subdivision, Unit I;

Thence, N00°39'43"W, a distance of 2,089.58 feet to the northwest corner of said Tract 1;

Thence, N89°20'03"E, a distance of 661.52 feet to a  $\frac{5}{8}$ " rebar found for the northeast corner of said Tract 1;

Thence, S00°40'52"E, a distance of 2089.62 feet to the point of beginning.

This tract contains 31.750 Acres (1,383,037 sq.ft.), more or less.

#### FREE CONSENT AND DEDICATION

THE SUBDIVISION HEREON DESCRIBED IS WITH THE FREE CONSENT AND IN ACCORDANCE WITH THE DESIRES OF THE UNDERSIGNED OWNER(S) AND/OR PROPRIETOR(S) THEREOF AND SAID OWNER(S) AND/OR PROPRIETOR(S) DO HEREBY DEDICATE ALL STREET AND PUBLIC RIGHT—OF—WAYS SHOWN HEREON TO THE CITY OF HOBBS IN FEE SIMPLE WITH WARRANTY COVENANTS AND DO HEREBY GRANT ALL EASEMENTS SHOWN HEREON. SAID OWNER(S) AND/OR PROPRIETOR(S) DO HEREBY CONSENT TO ALL OF THE FOREGOING AND DO HEREBY CERTIFY THAT THIS SUBDIVISION IS THEIR FREE ACT AND DEED. SAID OWNER(S) WARRANT THAT THEY HOLD AMONG THEM COMPLETE AND INDEFEASIBLE TITLE IN FEE SIMPLE TO THE LAND SUBDIVIDED.

OWNER: Lemke Development, Inc., a New Mexico corporation

By: John Lemke Title: President

**DESCRIPTION** 

JOHN LEMKE DATE

### ACKNOWLEDGEMENT:

	STATE OF)			
	)SS.			
	COUNTY OF)			
V	THIS,	2019,	BEFORE	ME

PERSONALLY APPEARED \_\_\_\_\_\_ KNOWN TO ME TO B THE PERSON(S) DESCRIBED IN AND WHO EXECUTED THE FOREGOING INSTRUMENT AND ACKNOWLEDGED THAT THEY EXECUTED THE SAME AS THEIR FREE ACT AND DEED.

WITNESS MY HAND AND OFFICIAL SEAL THE DAY AND YEAR LAST ABOVE WRITTEN.

NOTARY PUBLIC

MY COMMISSION EXPIRES

### TREASURER'S OFFICE CERTIFICATION

THIS IS TO CERTIFY THAT THE TAXES ARE CURRENT AND

PAID ON UPC #:\_\_\_\_\_

PROPERTY OWNER OF RECORD\_\_\_\_\_

LEA COUNTY

TREASURER'S OFFICE \_\_\_\_\_

DATE

# Fierro&Company ENGINEERING | SURVEYING

6300 MONTANO RD. NW, SUITE C ALBUQUERQUE, NM 87120 PH 505.352.8930 www.fierrocompany.com

### SURVEYOR'S CERTIFICATION

I, ROBERT J. FIERRO, NEW MEXICO PROFESSIONAL SURVEYOR NO. 22909, DO HEREBY CERTIFY THAT THIS PLAT OF SURVEY WAS PREPARED FROM FIELD NOTES OF AN ACTUAL GROUND SURVEY PERFORMED BY ME OR UNDER MY SUPERVISION; THAT IT ACCURATELY MEETS THE STANDARDS FOR LAND SURVEYS IN NEW MEXICO AS ADOPTED BY THE NEW MEXICO STATE BOARD OF REGISTRATION FOR PROFESSIONAL ENGINEERS AND PROFESSIONAL SURVEYORS; AND IS TRUE AND ACCURATE TO THE BEST OF MY KNOWLEDGE AND BELIEF.

ROBERT J. FIERRO,	Date
N.M.P.S. No. 22909	



# PLAT OF THE MEADOWS SUBDIVISION UNIT II

SECTION 4, TOWNSHIP 18 SOUTH,
RANGE 38 EAST, N.M.P.M.,
CITY OF HOBBS,
LEA COUNTY, NEW MEXICO
OCTOBER 2019


I, JAN FLETCHER, THE DULY APPOINTED AND ACTING CITY CLERK OF THE CITY OF


### CERTIFICATE OF MUNICIPAL APPROVAL

PLAT OF THE MEADOWS SUBDICOMMISSION OF THE CITY OF	VISION, UNIT HOBBS BY	II, TO THE CITY OF	HOBBS, WAS APPRO	OVED BY 1
RESOLUTION No ON	THE OF_	,2019	A.D.	
JAN FLETCHER, CITY CLERK				
ACKNOWLEDGMENT STATE OF NEW MEXICO	) )SS.			
COUNTY OF LEA	)			
THIS INSTRUMENT WAS ACKNO BY JAN FLETCHER.	WLEDGED BEF	ORE ME THISD	AY OF	,2019 A
NOTARY PUBLIC				
MY COMMISSION EXPIRES				
CERTIFICATE OF APPROVA BY THE CITY OF HOBBS F		OARD:		
THE PLAT, RESTRICTIONS AND OF,2019 A.D. BY				).
CHAIRMAN: WILLIAM M. HICKS,	III			
ACKNOWLEDGMENT STATE OF	) )SS.			
COUNTY OF	)			
THIS INSTRUMENT WAS ACKNOWN BY WILIAM M. HICKS.	VLEDGED BEFO	ORE ME THISD	AY OF	,2019,
NOTARY PUBLIC				
MY COMMISSION EXPIRES				

STATE OF NEW MEXICO COUNTY OF LEA FILED
,2019,
AT, O'CLOCKM AND RECORDED IN
BOOK
PAGE
, LEA COUNTY CLERK
BYDEPUTY


SHEET 1 OF 3

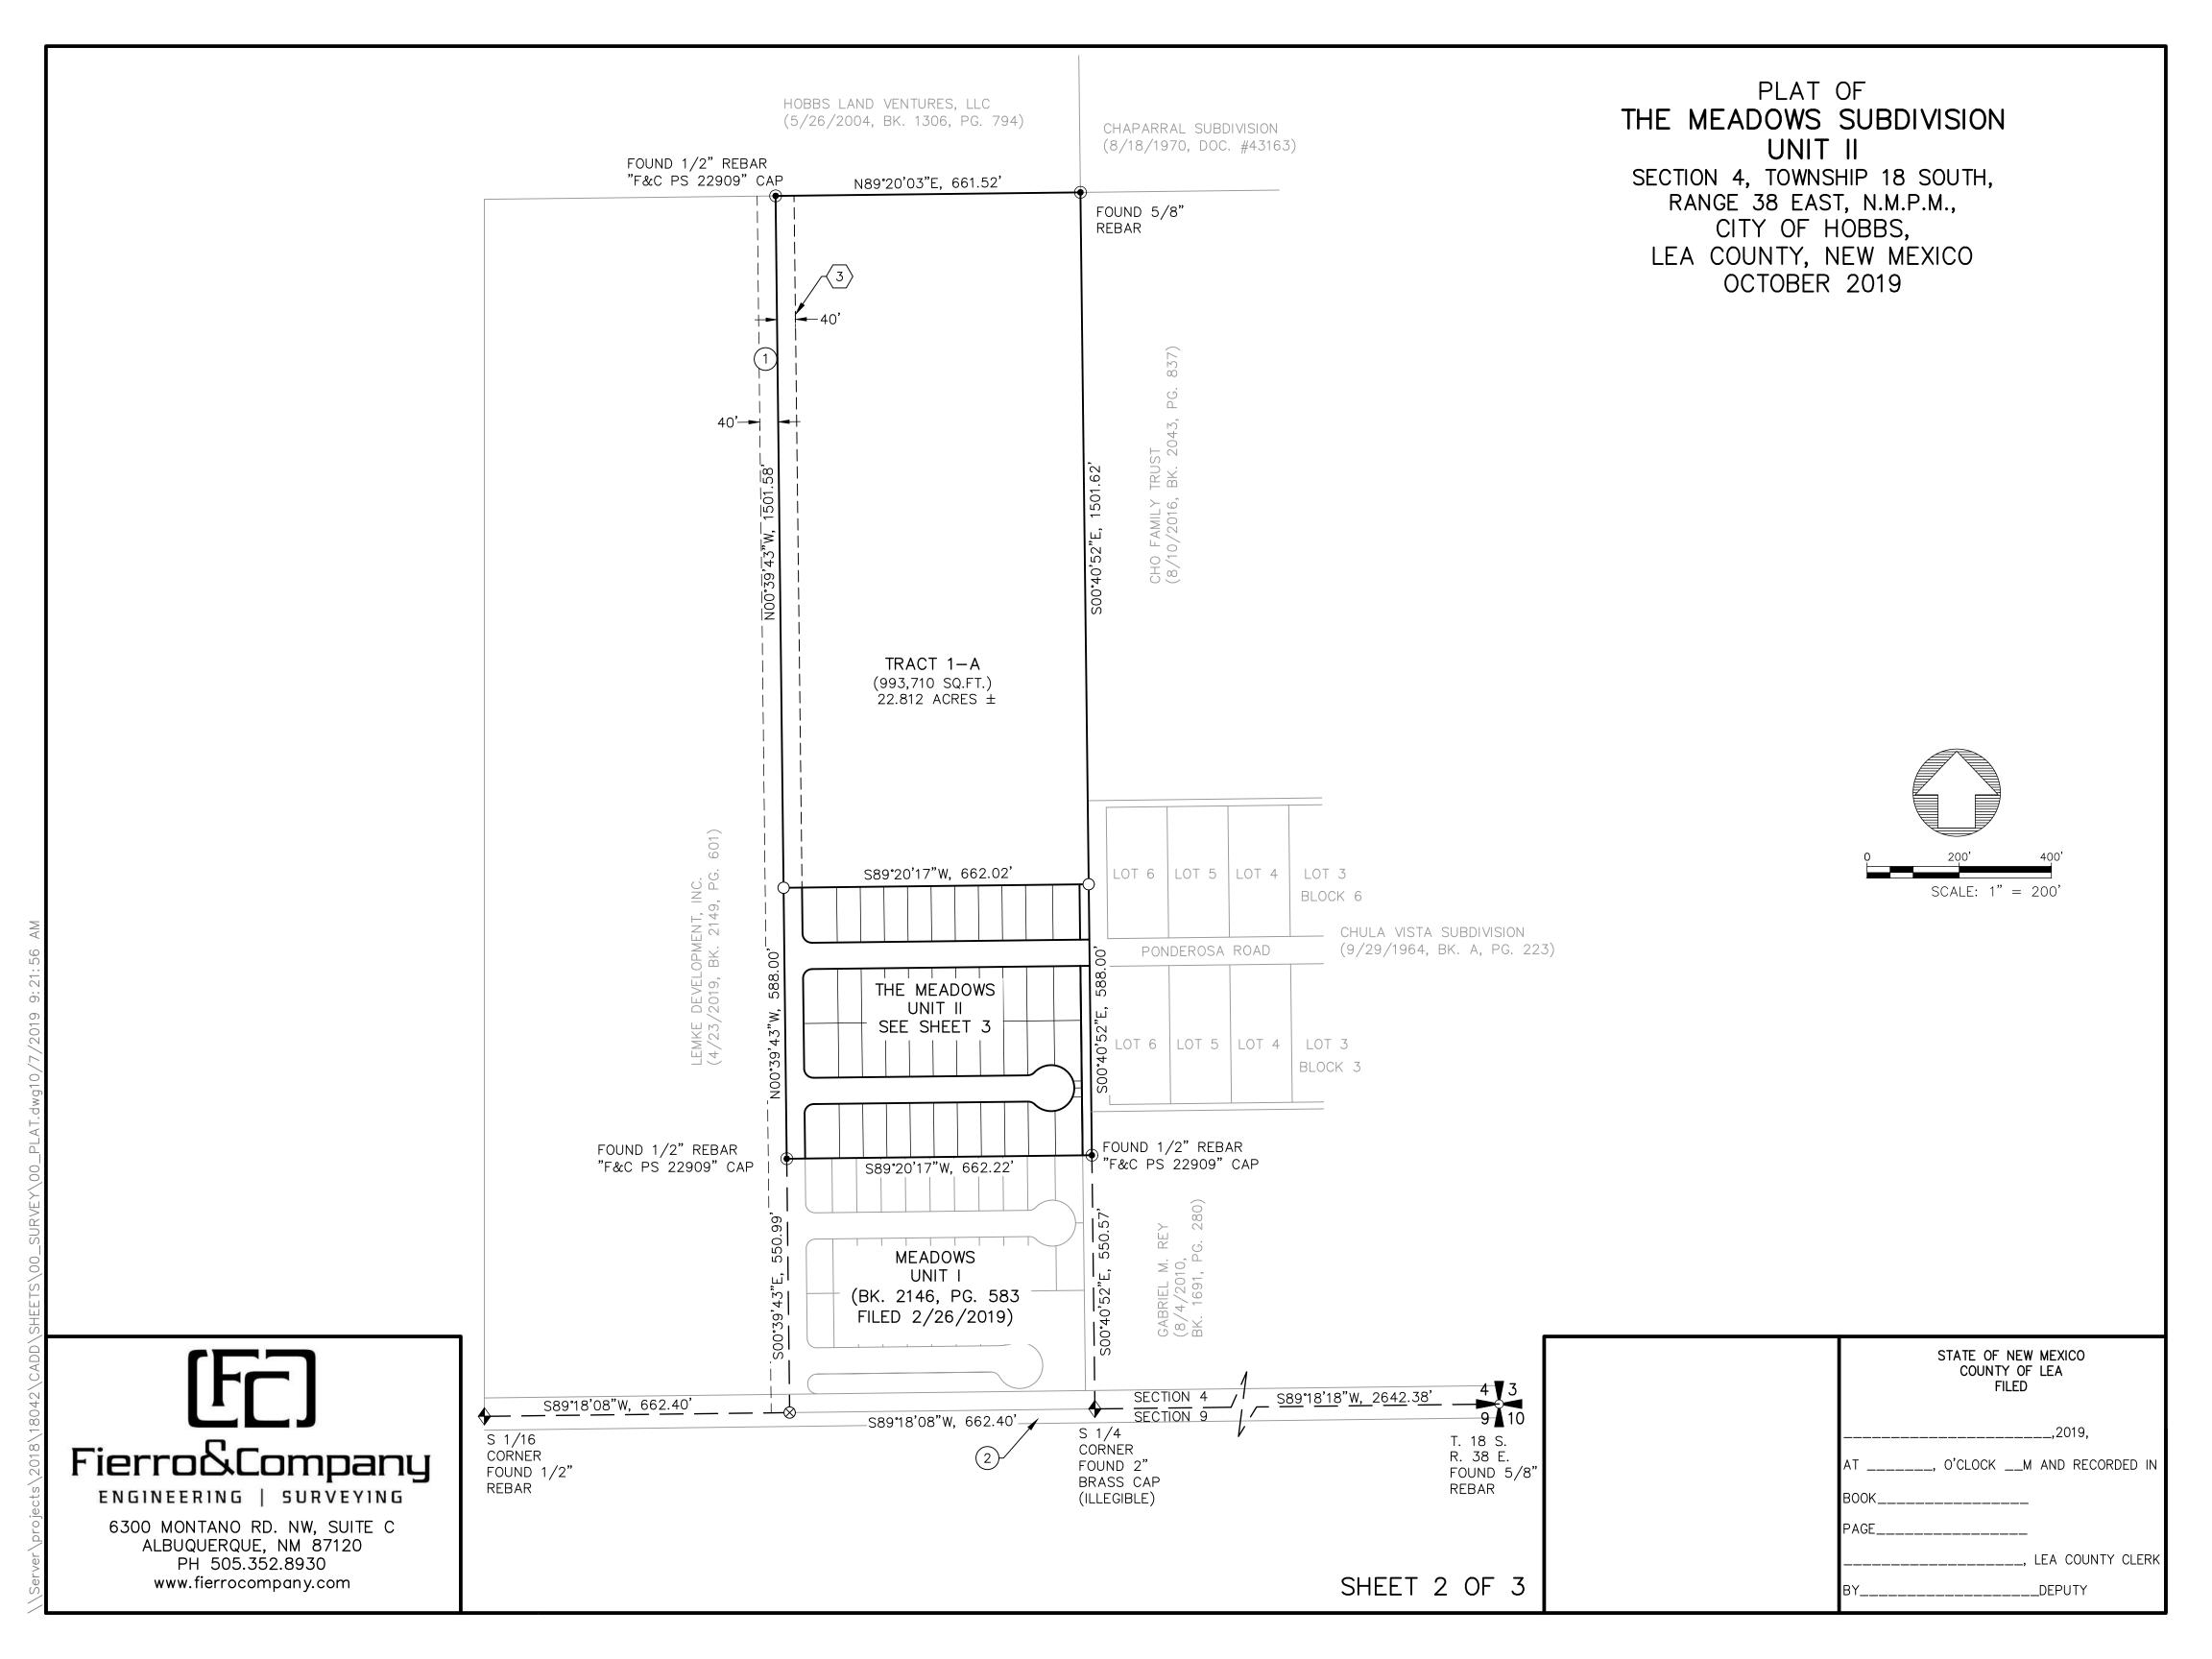

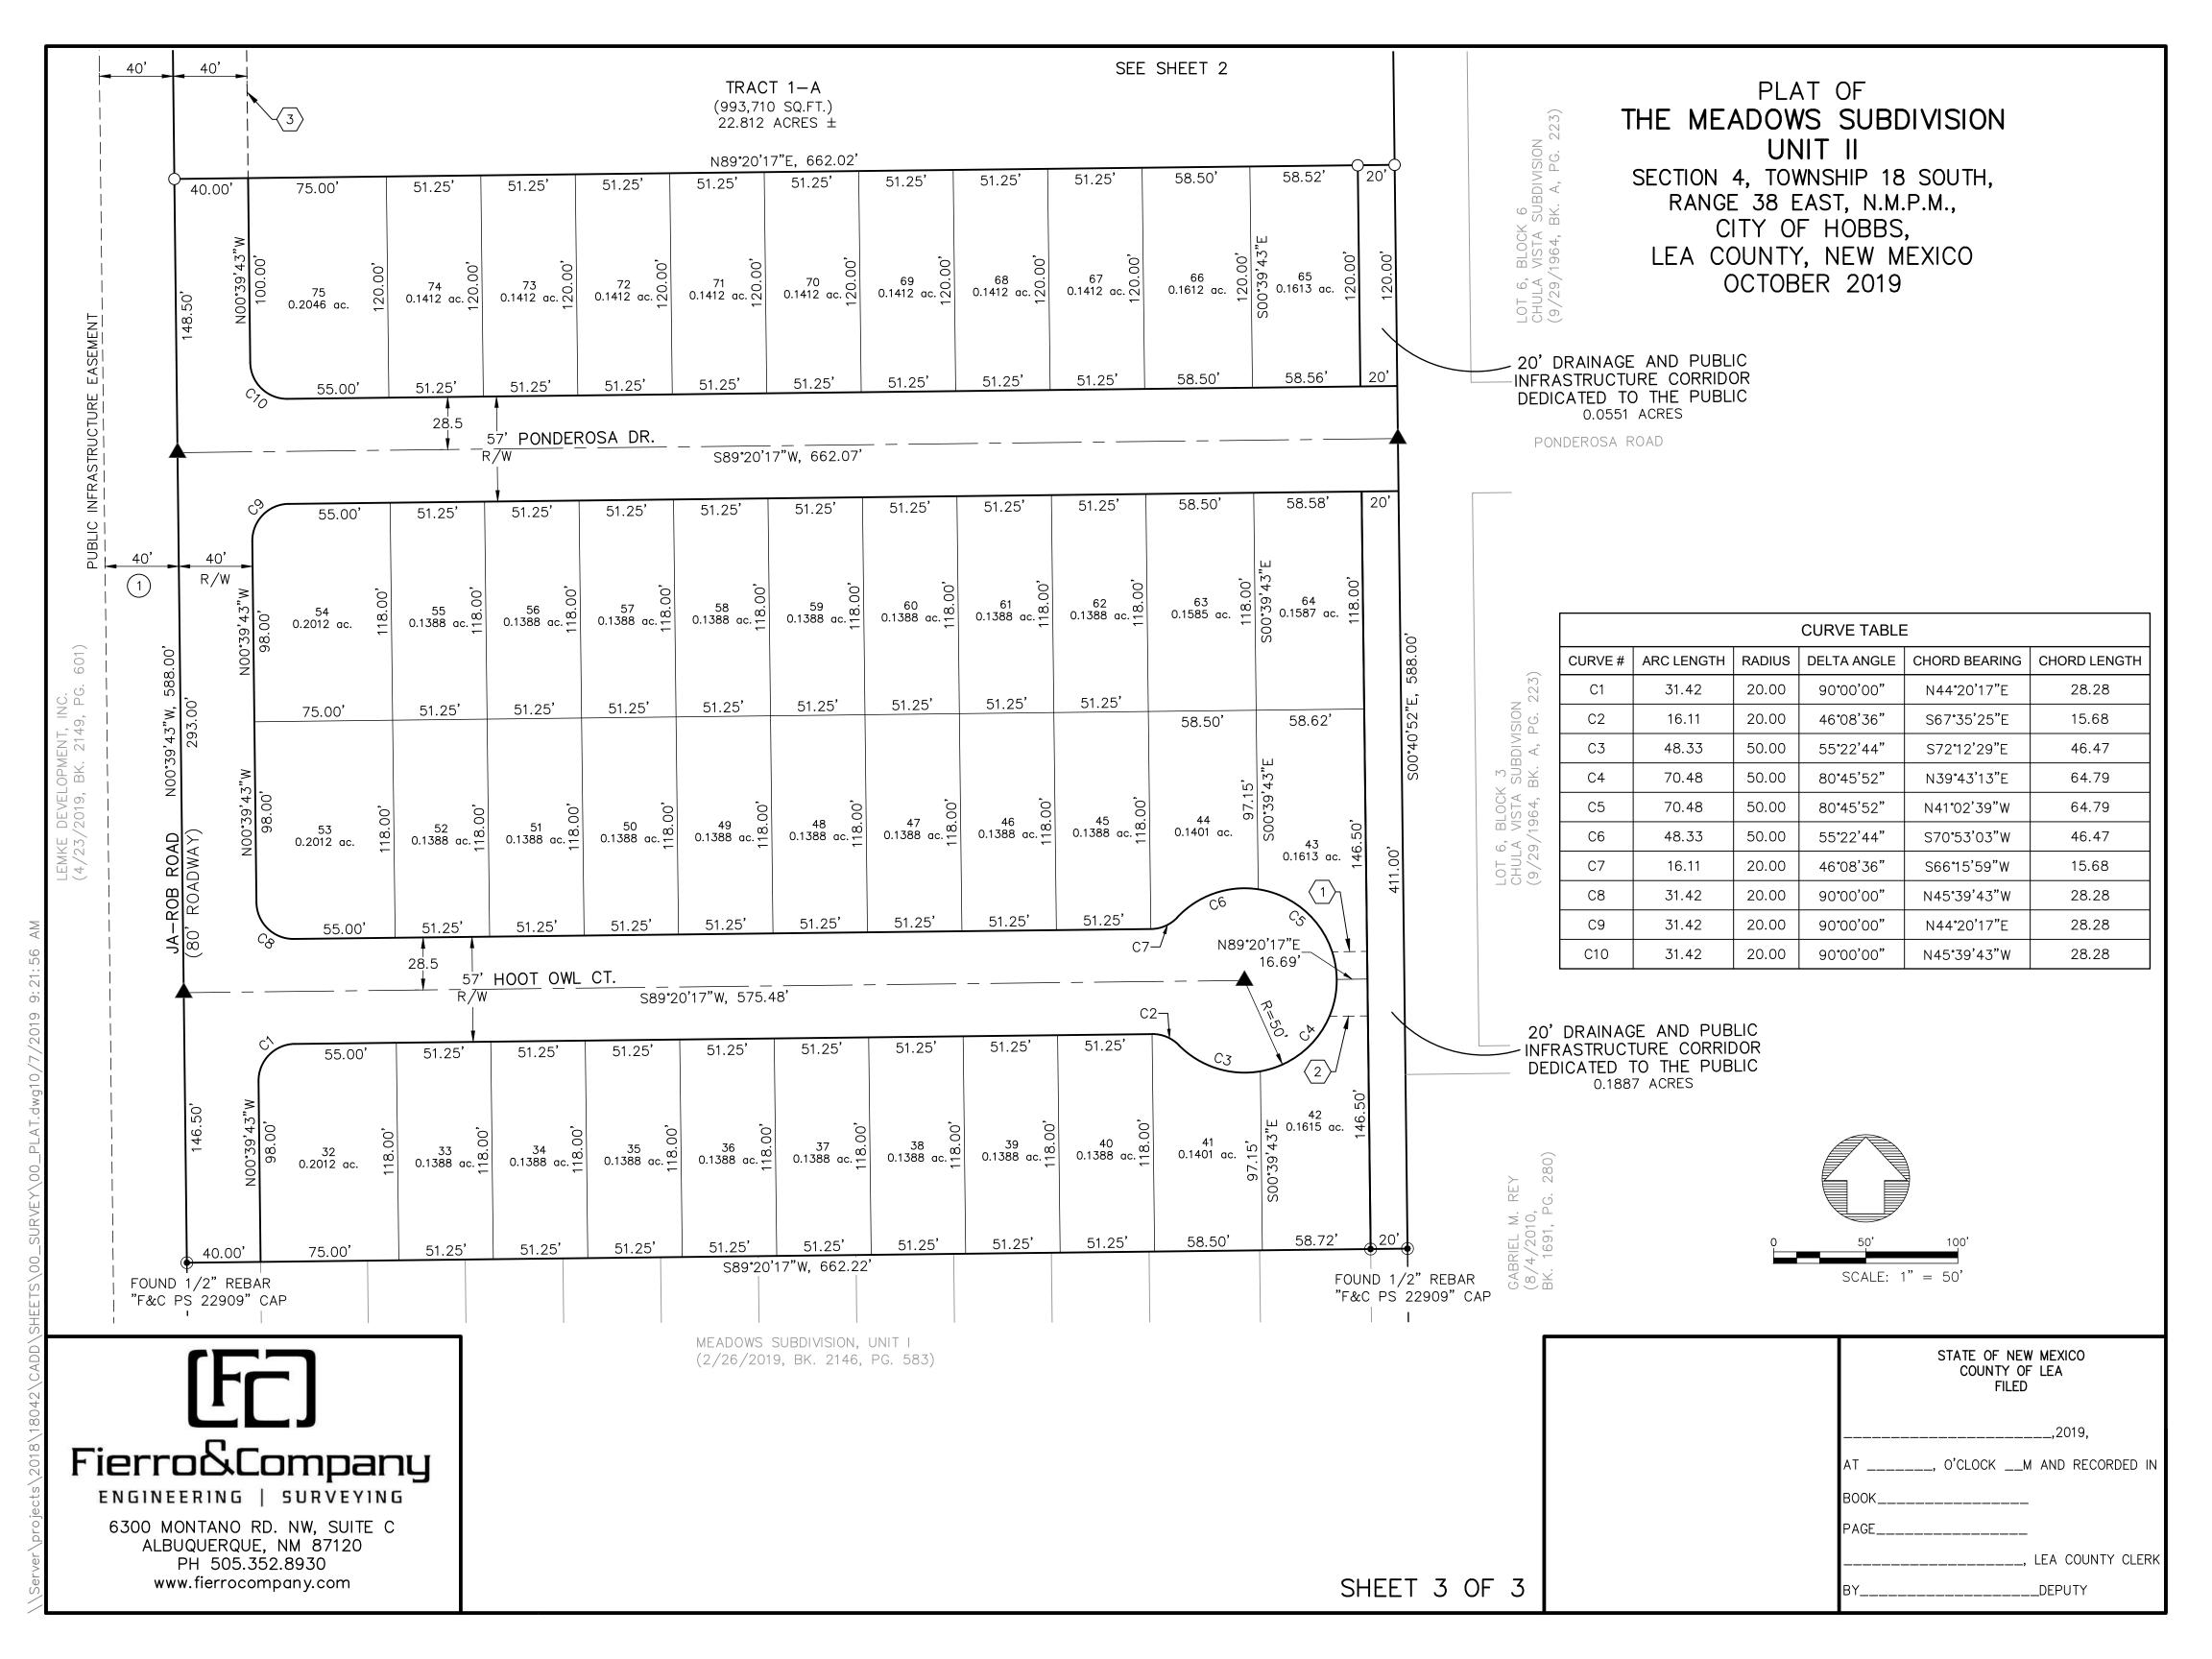



### October 15, 2019 Planning Board Regular Meeting

8)	Review Sketch Plan for proposed Subdivision located southwest of the intersection of Texas and Hannah, as submitted by property owner, Glen Payne.										

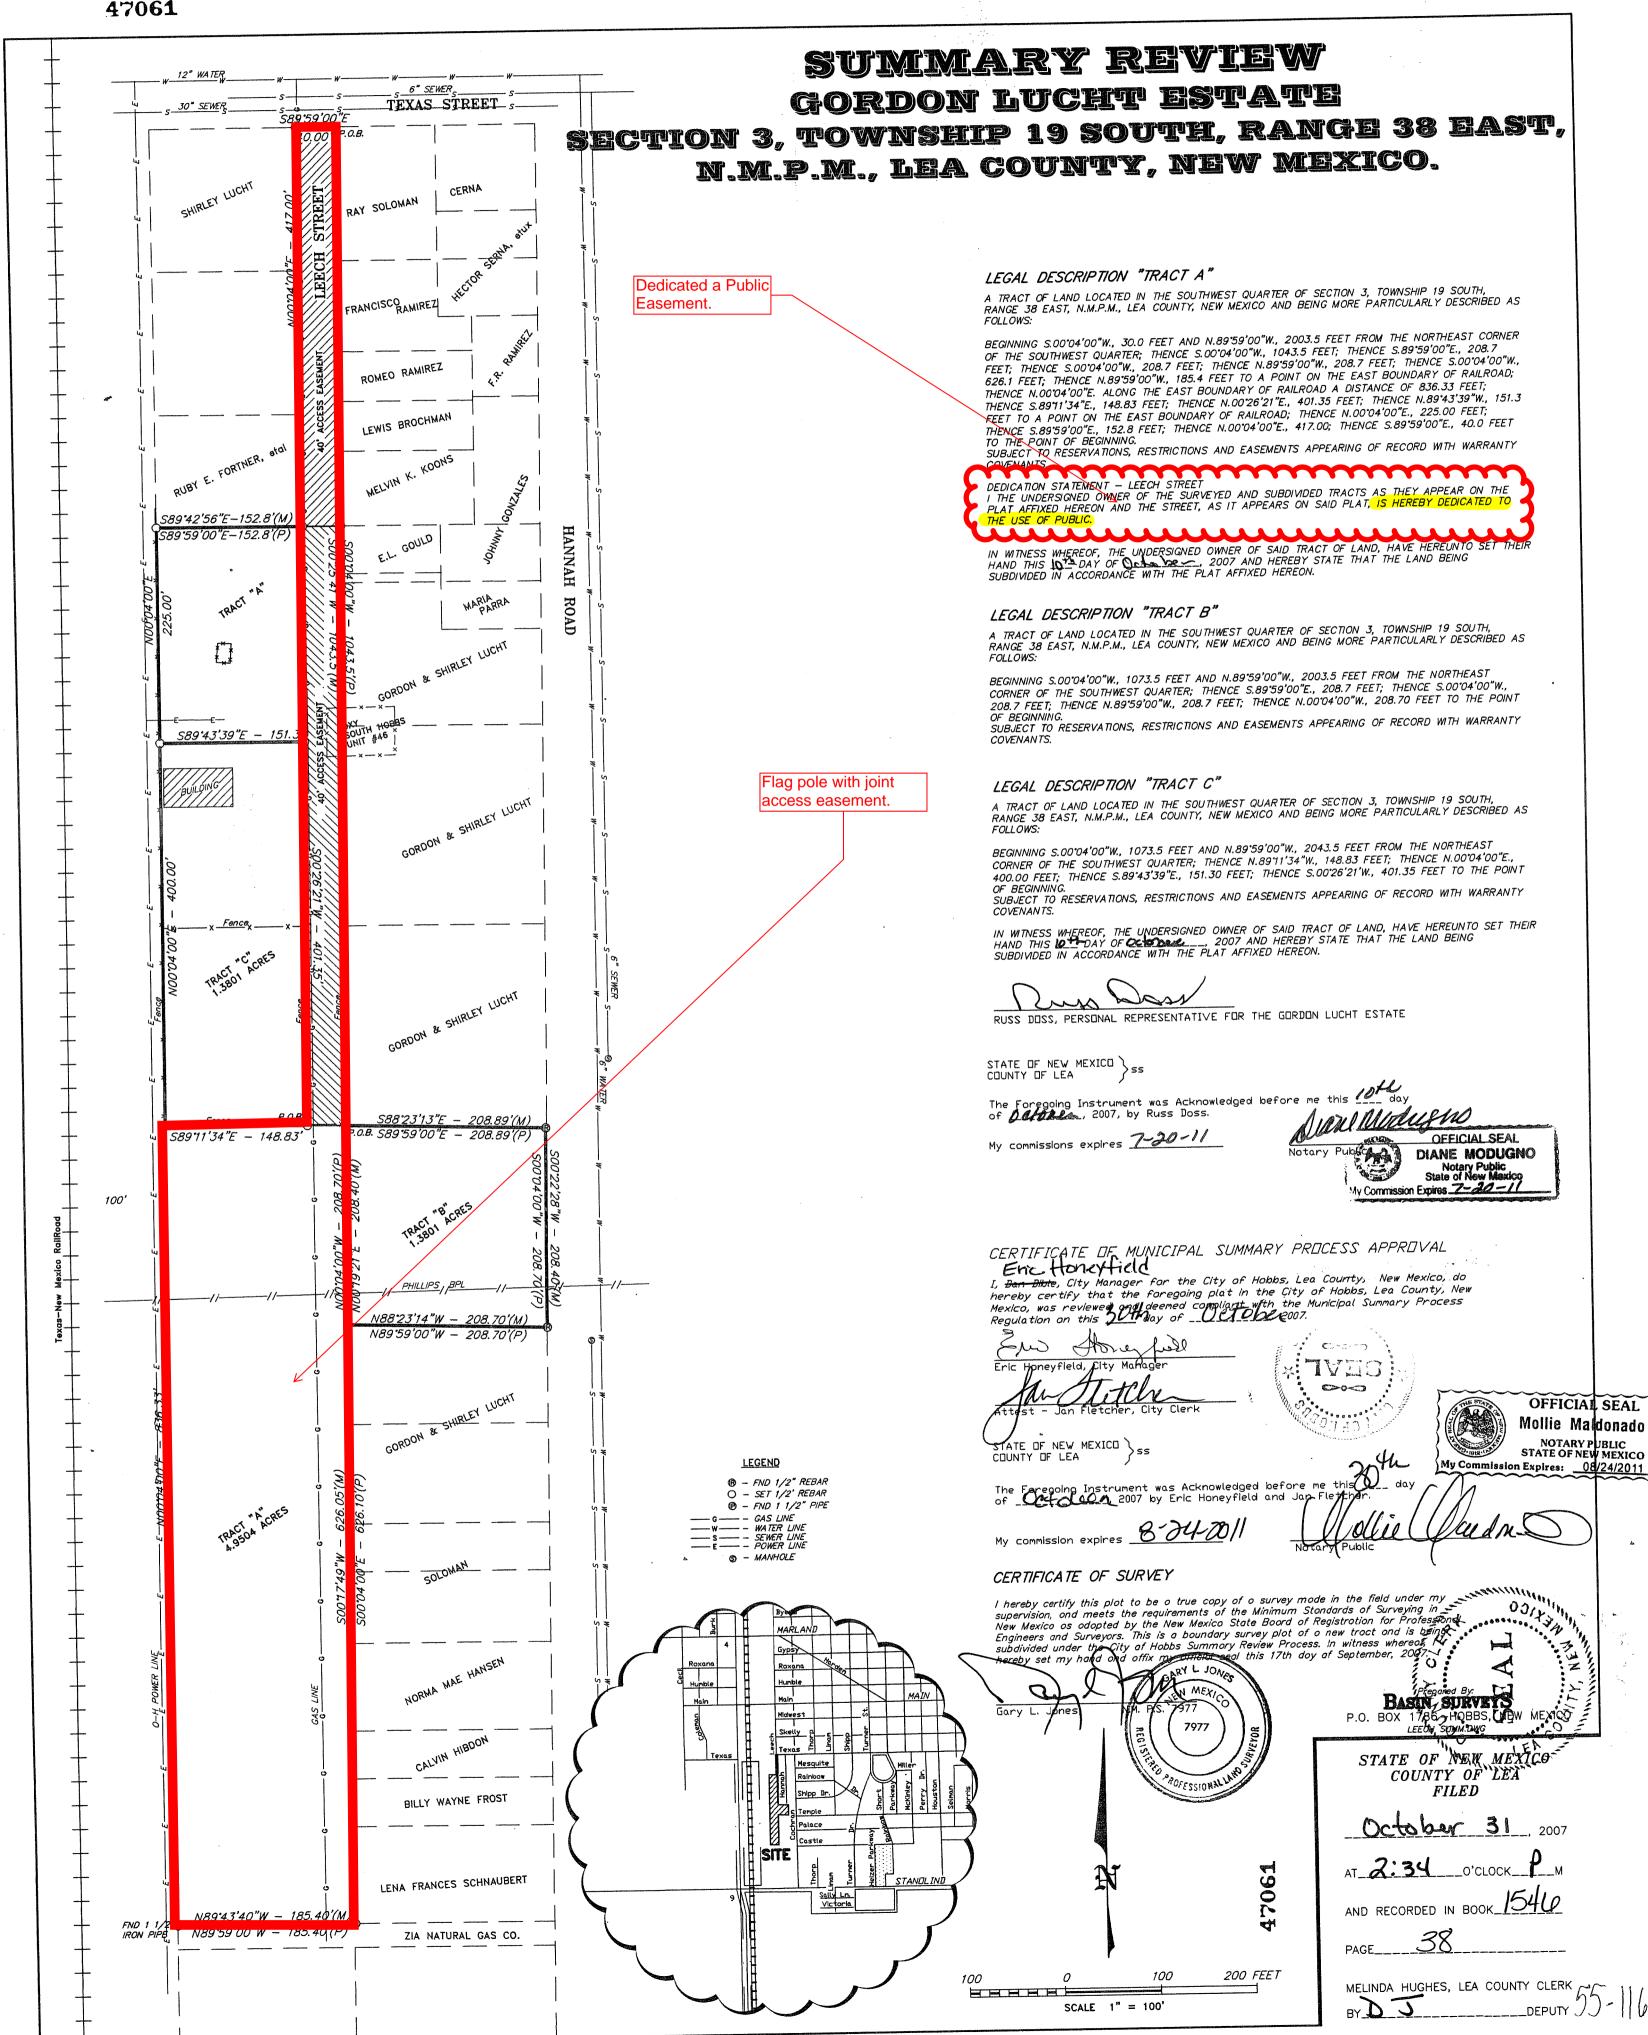

Replat approved administratively because eliminating a lot accessible only from an easement improved the situation.

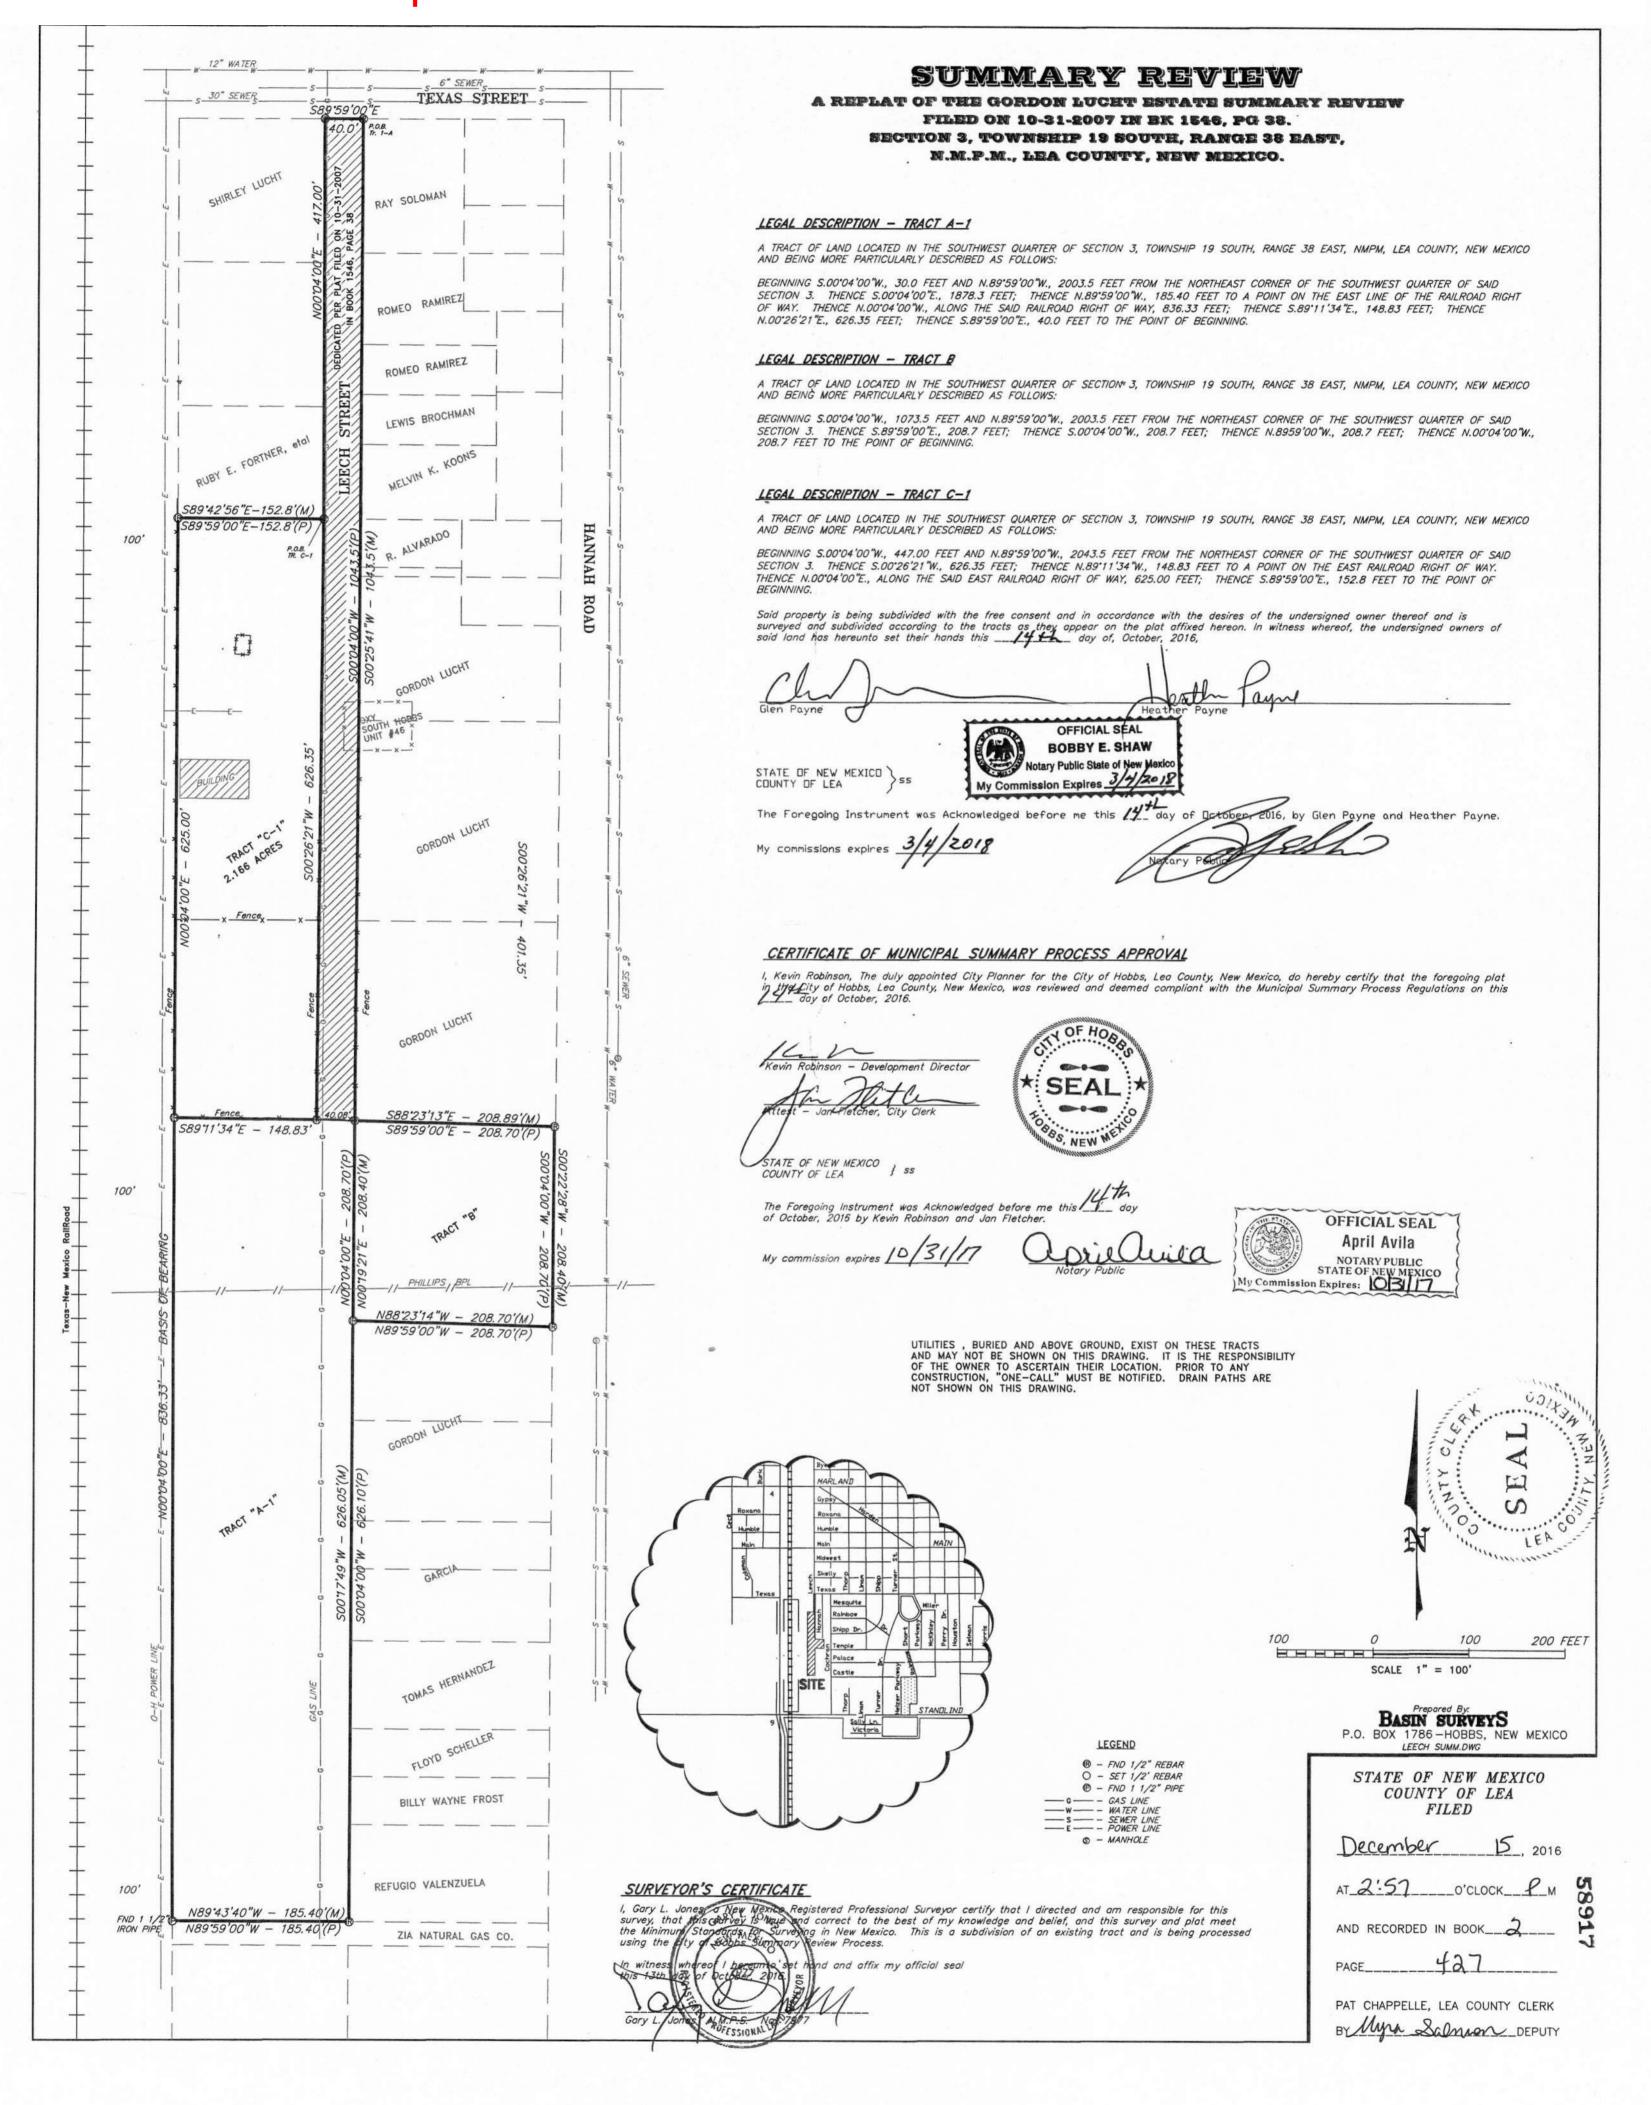

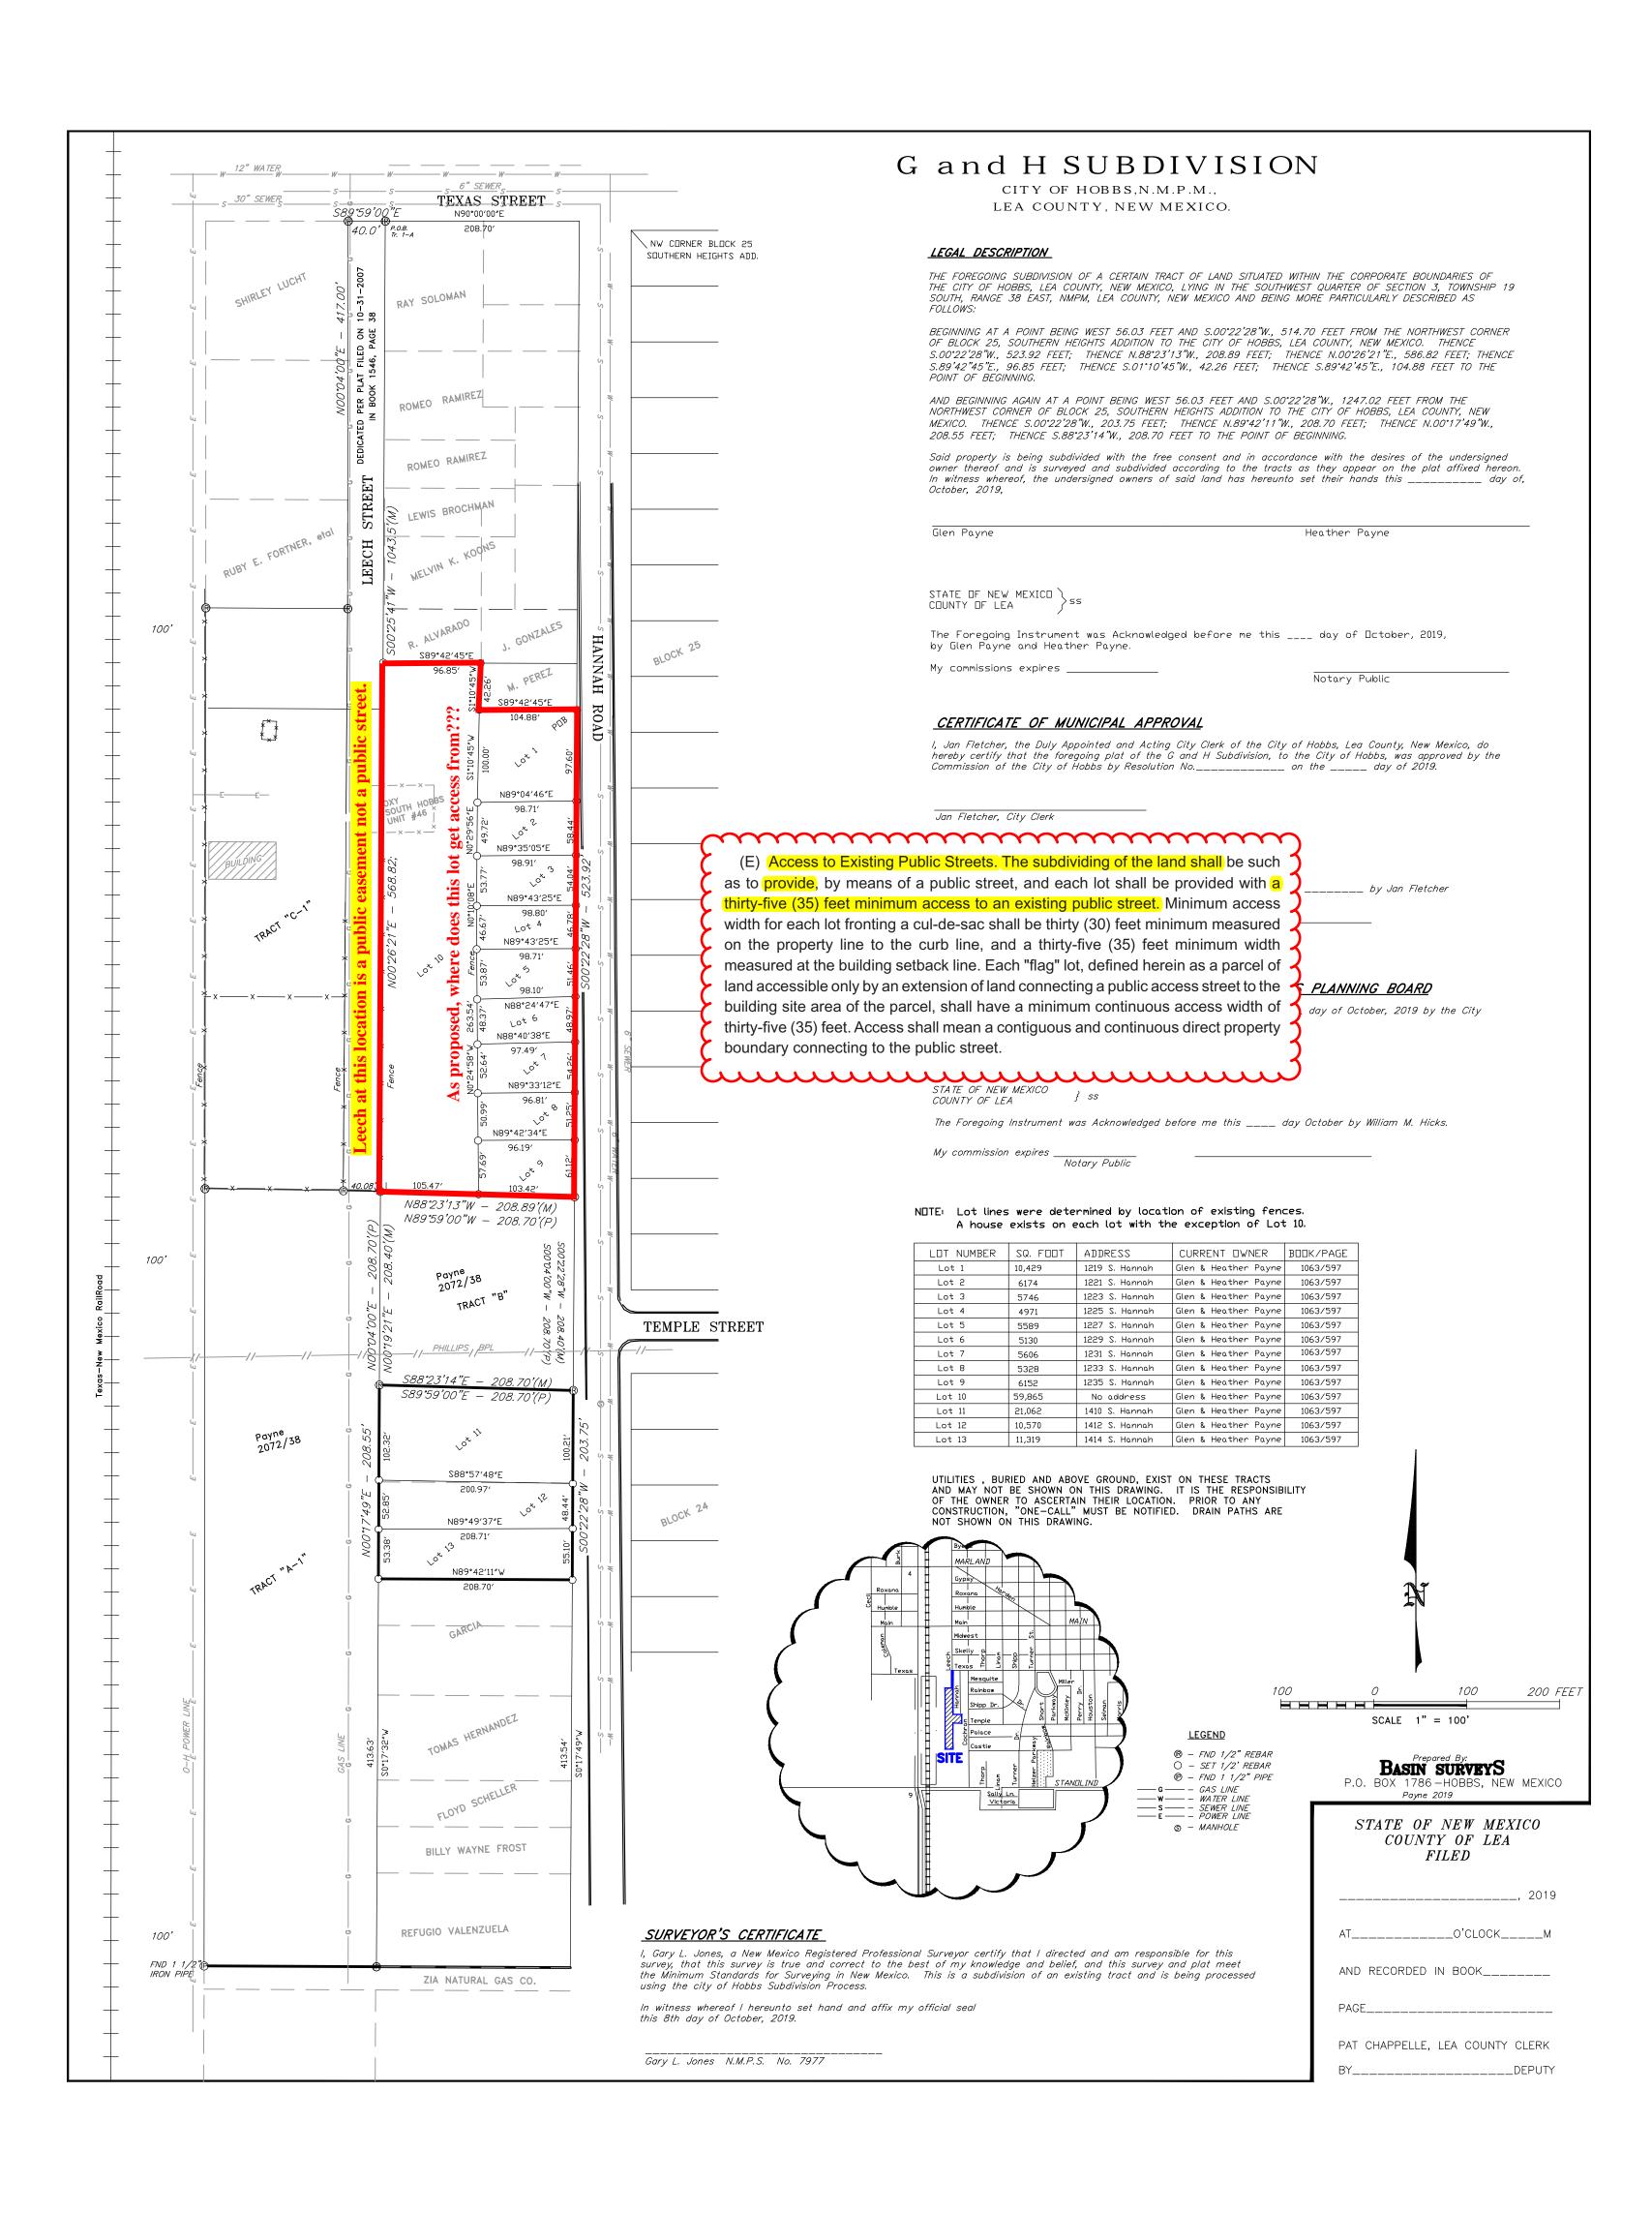



STATUS	STEWARD	ADDNO PRD	STNAME STTYPE	MSAG	LABEL	CITY	COUNTY	STATE 2	IP LOCTYPE	HABTYPE	ADDESIGN	LATLONG	POLICE	PDBEAT FIRE	AMBULANCE	LAST_EDITE	LAST_EDI_1
ACTIVE	HOBBS	1301 S	HANNAH RD	HOBBSNM	1301 S HANNAH RE	HOBBS	LEA	NM :	88240 RESID-MH-SGL	HABITABLE	PERMANENT	32.41' 10.860"" N -103.8' 32.017""	W HOBBS P	D 1 HOBBS FD	HOBBS EMS	TSTAGGS	8/23/2017 0:00
ACTIVE	HOBBS	1203 S	HANNAH RD	HOBBSNM	1203 S HANNAH RE	HOBBS	LEA	NM :	88240 RESIDENCE	HABITABLE	PERMANENT	32.41' 20.340"" N -103.8' 31.766""	W HOBBS P	D 1 HOBBS FD	HOBBS EMS	TSTAGGS	8/23/2017 0:00
ACTIVE	HOBBS	1205 S	HANNAH RD	HOBBSNM	1205 S HANNAH RE	HOBBS	LEA	NM	88240 RESIDENCE	HABITABLE	PERMANENT	32.41' 19.704"" N -103.8' 31.740""	W HOBBS P	D 1 HOBBS FD	HOBBS EMS	TSTAGGS	8/23/2017 0:00
ACTIVE	HOBBS	1214 S	HANNAH RD	HOBBSNM	1214 S HANNAH RE	HOBBS	LEA	NM	88240 RESIDENCE	HABITABLE	PERMANENT	32.41' 17.093"" N -103.8' 31.700""	W HOBBS P	D 1 HOBBS FD	HOBBS EMS	TSTAGGS	8/23/2017 0:00
ACTIVE	HOBBS	1217 S	HANNAH RD	HOBBSNM	1217 S HANNAH RE	HOBBS	LEA	NM :	88240 RESIDENCE	HABITABLE	PERMANENT	32.41' 16.476"" N -103.8' 31.864""	W HOBBS P	D 1 HOBBS FD	HOBBS EMS	TSTAGGS	8/23/2017 0:00
ACTIVE	HOBBS	1211 S	HANNAH RD	HOBBSNM	1211 S HANNAH RE	HOBBS	LEA	NM :	88240 RESIDENCE	HABITABLE	PERMANENT	32.41' 18.990"" N -103.8' 31.692""	W HOBBS P	D 1 HOBBS FD	HOBBS EMS	TSTAGGS	8/23/2017 0:00
ACTIVE	HOBBS	1219 S	HANNAH RD	HOBBSNM	1219 S HANNAH RE	HOBBS	LEA	NM :	88240 RESIDENCE	HABITABLE	PERMANENT	32.41' 15.518"" N -103.8' 31.833""	W HOBBS P	D 1 HOBBS FD	HOBBS EMS	TSTAGGS	8/23/2017 0:00
ACTIVE	HOBBS	1231 S	HANNAH RD	HOBBSNM	1231 S HANNAH RE	HOBBS	LEA	NM :	88240 RESIDENCE	HABITABLE	PERMANENT	32.41' 12.362"" N -103.8' 31.872""	W HOBBS P	D 1 HOBBS FD	HOBBS EMS	TSTAGGS	8/23/2017 0:00
ACTIVE	HOBBS	1221 S	HANNAH RD	HOBBSNM	1221 S HANNAH RE	HOBBS	LEA	NM :	88240 RESIDENCE	HABITABLE	PERMANENT	32.41' 14.892"" N -103.8' 31.877""	W HOBBS P	D 1 HOBBS FD	HOBBS EMS	TSTAGGS	8/23/2017 0:00
ACTIVE	HOBBS	1229 S	HANNAH RD	HOBBSNM	1229 S HANNAH RE	HOBBS	LEA	NM	88240 RESIDENCE	HABITABLE	PERMANENT	32.41' 12.974"" N -103.8' 31.901""	W HOBBS P	D 1 HOBBS FD	HOBBS EMS	TSTAGGS	8/23/2017 0:00
ACTIVE	HOBBS	1223 S	HANNAH RD	HOBBSNM	1223 S HANNAH RE	HOBBS	LEA	NM	88240 RESIDENCE	HABITABLE	PERMANENT	32.41' 14.388"" N -103.8' 31.901""	W HOBBS P	D 1 HOBBS FD	HOBBS EMS	TSTAGGS	8/23/2017 0:00
ACTIVE	HOBBS	1235 S	HANNAH RD	HOBBSNM	1235 S HANNAH RE	HOBBS	LEA	NM	88240 RESIDENCE	HABITABLE	PERMANENT	32.41' 11.321"" N -103.8' 31.851""	W HOBBS P	D 1 HOBBS FD	HOBBS EMS	TSTAGGS	8/23/2017 0:00
ACTIVE	HOBBS	1227 S	HANNAH RD	HOBBSNM	1227 S HANNAH RE	HOBBS	LEA	NM	88240 RESIDENCE	HABITABLE	PERMANENT	32.41' 13.407"" N -103.8' 32.112""	W HOBBS P	D 1 HOBBS FD	HOBBS EMS	TSTAGGS	8/23/2017 0:00
ACTIVE	HOBBS	1233 S	HANNAH RD	HOBBSNM	1233 S HANNAH RE	HOBBS	LEA	NM	88240 RESIDENCE	HABITABLE	PERMANENT	32.41' 11.923"" N -103.8' 31.926""	W HOBBS P	D 1 HOBBS FD	HOBBS EMS	TSTAGGS	8/23/2017 0:00
ACTIVE	HOBBS	1225 S	HANNAH RD	HOBBSNM	1225 S HANNAH RE	HOBBS	LEA	NM	88240 RESIDENCE	HABITABLE	PERMANENT	32.41' 13.831"" N -103.8' 31.880""	W HOBBS P	D 1 HOBBS FD	HOBBS EMS	TSTAGGS	8/23/2017 0:00
ACTIVE	HOBBS	1212 S	HANNAH RD	HOBBSNM	1212 S HANNAH RE	HOBBS	LEA	NM	88240 RESID-MH-SGL	HABITABLE	PERMANENT	32.41' 18.207"" N -103.8' 31.575""	W HOBBS P	D 1 HOBBS FD	HOBBS EMS	TSTAGGS	8/23/2017 0:00
16	i																
ACTIVE	HOBBS	1214 S	LEECH ST	HOBBSNM	1214 S LEECH ST	HOBBS	LEA	NM	88240 RESIDENCE	HABITABLE	PERMANENT	32.41' 18.246"" N -103.8' 33.445""	W HOBBS P	D 1 HOBBS FD	HOBBS EMS	TSTAGGS	8/23/2017 0:00
ACTIVE	HOBBS	1216 S	LEECH ST	HOBBSNM	1216 S LEECH ST	HOBBS	LEA	NM	88240 RESIDENCE	HABITABLE	PERMANENT	32.41' 17.631"" N -103.8' 33.098""	W HOBBS P			TSTAGGS	8/23/2017 0:00
ACTIVE	HOBBS	1230 S	LEECH ST	HOBBSNM	1230 S LEECH ST	HOBBS	LEA	NM :	88240 RESIDENCE	HABITABLE	PERMANENT	32.41' 13.411"" N -103.8' 33.282""	W HOBBS P	D 1 HOBBS FD	HOBBS EMS	TSTAGGS	8/23/2017 0:00
3																	
	HOBBS	519 W	TEXAS ST		519 W TEXAS ST	HOBBS			88240 RESIDENCE			32.41' 20.948"" N -103.8' 32.849""				TSTAGGS	8/23/2017 0:00
ACTIVE	HOBBS	511 W	TEXAS ST	HOBBSNM	511 W TEXAS ST	HOBBS	LEA	NM :	88240 RESIDENCE	HABITABLE	PERMANENT	32.41' 20.920"" N -103.8' 31.785""	W HOBBS P	D 1 HOBBS FD	HOBBS EMS	TSTAGGS	8/23/2017 0:00
2	!																

37 total structures and 21 "addressable" structures.